EXHIBIT A

DESCRIPTION OF PROPERTY

Property located in Chatham County, North Carolina

All that certain lot or parcel of land situate in Hadley Township, Chatham County, North Carolina and more particularly described as follows:

Tract 1: All that certain tract or parcel of land containing 38 acres, more or less, and being all of the property described in Deed recorded in Book 270 at Page 91, Chatham County Registry, save and except 2.00 acres, more or less, conveyed to Don E. Bush.

LESS AND EXCEPT that portion of property conveyed to Rhonda L. Nunn and Charles E. Nunn from Jerry R. Justice and Anne C. Justice by North Carolina General Warranty Deed dated March 18, 1998 and recorded April 3, 1998 in Deed Book 747, Page 700.

AND BEING a portion of the same property conveyed to Jerry R. Justice from Elva W. Justice by North Carolina General Warranty Deed dated September 13, 1995 and recorded September 29, 1995 in Deed Book 675, Page 451.

Tax Parcel No. 0010843

EXHIBIT B

SURVEY OF THE PREMISES

SEE ATTACHED

SURVEYOR'S NOTES:

- 83 (CORS), determined by GPS Survey NORTH ORIENTATION: North Carolina State Plane Coordinate System, NAD
- Station (CORS) Benchmark as noted hereon. Onsite benchmark is as shown ELEVATION DATUM: NAVD88, relative to Continuously Operating Reference
- Registered Land Surveyor. Date of field survey is 12-03-2019 This is a Tower Site Survey, made on the ground under the supervision of a
- Instruments Used: Topcon GTS 212 and Prism, Topcon Hiperlite Plus GPS,
- and to within ± 3 feet vertically (FAA Accuracy Code 1A). for the centerline of the tower are accurate to within ± 15 feet horizontally Surveyor hereby states the Geodetic Coordinates and the elevation shown TDS Nomad and/or Carlson Surveyor Data Collector.
- by the State Board for a Class B Survey. Field traverse did not require Survey shown hereon conforms to the Minimum Requirements as set forth
- specifically shown hereon in the vicinity of surveyed property. Improvements (Utilities, Buildings, Trees, Fences, etc) not located, unless No underground utilities, underground encroachments or building
- regional or local agency, board, commission or other similar entity. Survey as is not intended to delineate the regulatory jurisdiction of any federal, state, This survey was conducted for the purpose of a Tower Site Survey only, and otherwise shown. foundations were measured or located as a part of this survey, unless
- Attention is directed to the fact that this survey may have been reduced or enlarged in size due to reproduction. This should be taken into consideration published is not intended to be suitable for recording as a Subdivision Plat when obtaining scaled data.

10.

- This survey is not valid without the original signature and the original seal of a State-Licensed Land Surveyor, and is not complete without all sheets.
- This survey does not constitute a complete boundary survey of the Parent Tract, or adjoining Parcels.

12. H

Title Examination was available at time of Survey.

14

of Minimal Flood Hazard FLOOD ZONE DATA: By graphic plotting only, Lessee's Premises and Map Community Panel No.3710972400K dated 11/17/20017. Zone X; Areas Easement(s) appear to lie within ZONE "X" per F.E.M.A Flood Insurance Rate

== STORMWATER PIPE

FENCE UNPAVED ROAD EDGE PAVEMENT EDGE

 ACCESS/UTILITY ESMT — TAX PARCEL BOUNDARY

LESSEE'S PREMISES EXISTING EASEMENT

CHECKED BY: TLS DRAWN BY: DLH SEE ISSUE LIST, SHEET NO 1 ISSUE NO: 0 ISSUE DATE: 12-31-2019

APPROVED BY: DLC

COVER SHEET

SHEET 1 OF 5

DEED LINE 1' CONTOURS 5" CONTOURS TREE LINE DITCH

SURVEYOR'S CERTIFICATION:

To: Celico Partnership, d/b}a/ Verizon Wirelss: I, Donald Contell, certify that this project was completed under my direct and responsible charge from an actual Ground Survey made under my supervision.



PROPOSED TOWER DATA


Latitude: 35° 47' 12.89" NORTH

Longitude: Ground Elevation: 484.0 feet AMSL NAVD88 79° 14' 41.19" WEST

CORS Benchmark: DL3891 NCJL

SURVEY RELEASE DATA

| 41 | DETAILS | DATE | DRAWN |
|----|-----------------------|------------|-------|
| 0 | Original Survey Issue | 12-31-2019 | PU |

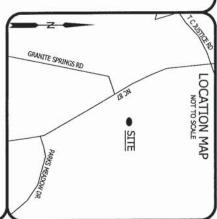

CELLCO PARTNERSHIP Professional Land Surveyor DONALD L. CORDELL NC License No: L-3037 2857 Camp Creek Road Murphy, NC 28906 (828) 494-7058

PREPARED FOR

/erizon

d/b/a/ Verizon Wireless

SITE NAME: LUTTERLOH

NC Highway 87 North, Pittsboro, NC 27312

Hadley Township, Chatham County, North Carolina

TOWER SITE SURVEY

R/W, ROW

回り

LEGEND UTILITY POLE TELECOM JUNCTION

g

POINT OF COMMENCEMENT

EASEMENT ACCESS/UTILITY RIGHT-OF-WAY

SQUARE FEET POINT OF BEGINNING

Location Code: 431701

PROPERTY INFORMATION

PARENT PARCEL A. JERRY R. JUSTICE TAX PARCEL: 0010843 DEED BOOK 675, PAGE 451

ADJOINING TAX PARCELS B. LARRY F. JUSTICE HEIRS TAX PARCEL: 0010862 **DEED BOOK 675, PAGE 463**

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9

C. JERRY R. JUSTICE
TAX PARCEL: 0010876
DEED BOOK 675, PAGE 451

D. SHERRILL LINDLEY ...
TAX PARCEL: 0061957
DEED BOOK 499, PAGE 542 Ĭμ

E. GREGORY OLIVER ...
TAX PARCEL: 0010818
DEED BOOK 1891, PAGE 296
PLAT BOOK 2003, PAGE 213

F. MICHAEL EDWARD STANO TR TAX PARCEL: 0080649
DEED BOOK 2031, PAGE 0055
PLAT BOOK 2003, PAGE 213

HIGHNAY #87 NORTH JA

D

I

ð DEED BOOK 1812, PAGE 980 PLAT BOOK 2003, PAGE 213 KITTRELL ANNE DESBON TAX PARCEL: 0080648

H. RHONDA L. NUNN
CHARLES E. NUNN
TAX PARCEL: 0074285
DEED BOOK 747, PAGE 700
PLAT BOOK 98, PAGE 91

B

TOWER SITE SURVEY

SITE NAME: LUTTERLOH Location Code: 431701

NC Highway 87 North, Pittsboro, NC 27312

Hadley Township, Chatham County, North Carolina

CELLCO PARTNERSHIP verizon PREPARED FOR

d/b/a/ Verizon Wireless

Professional Land Surveyor

2857 Camp Creek Road Murphy, NC 28906 (828) 494-7058 NC License No: L-3037 DONALD L. CORDELL

SURVEY & MAP CAVEATS: Surveyed Data is as shown on Survey Map Sheets herein.

NORTH CAROLINA STATE PLANE

0


This is not a Boundary Survey of Parent Tax Parcel or adjoiners. Parent Parcel Property lines are shown based on Tax Kep Data, Plats and/or Deeds.


APPROX SCALE: 1in = 300' 600

OVERVIEW

SHEET 2 OF 5

DRAWN BY: DLH
CHECKED BY: TLS
APPROVED BY: DLC ISSUE NO: 0
ISSUE DATE: 12-31-2019
SEE ISSUE LIST, SHEET NO 1

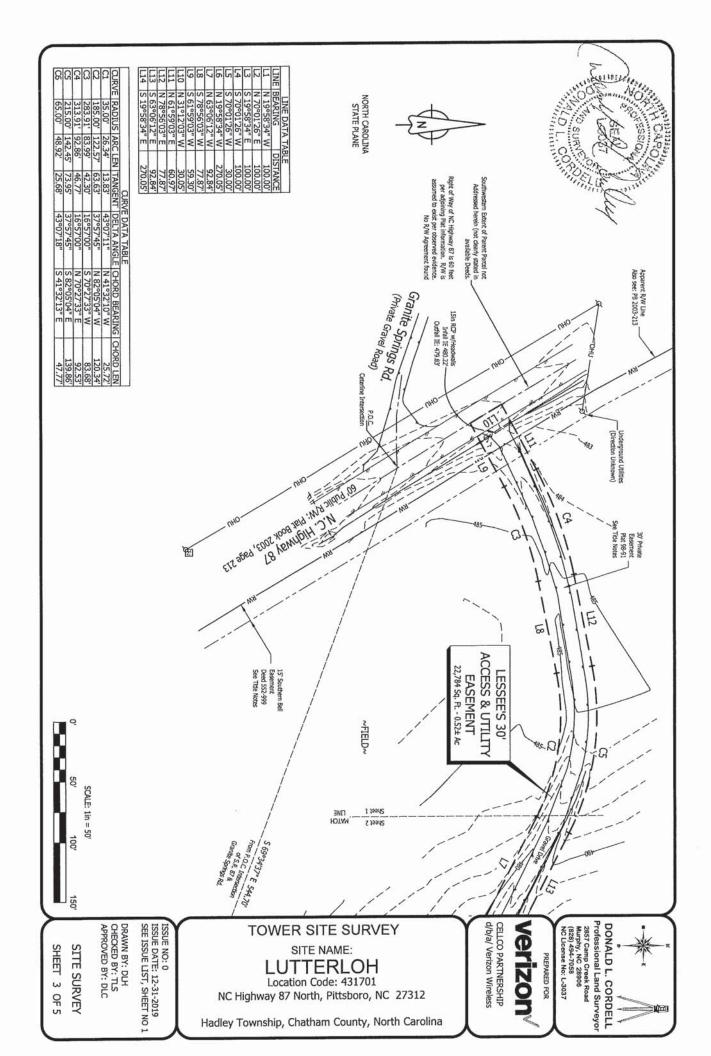

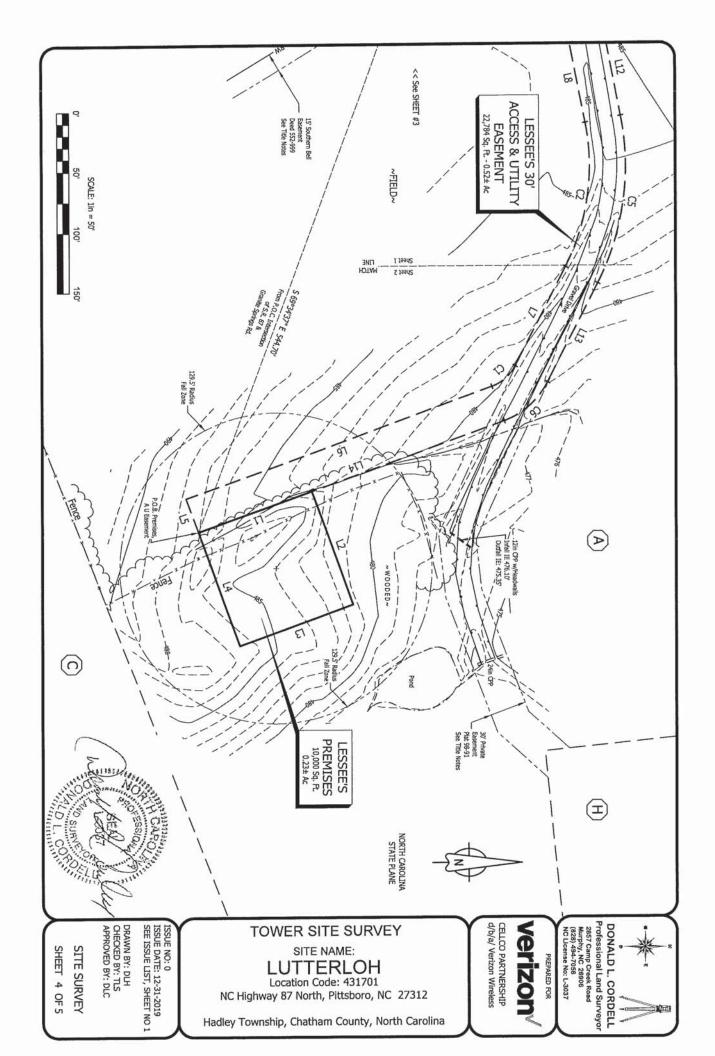

LESSEE'S PREMISES

Situated in the Hadley Township, Chatham County, North Carolina. Being a Lessee's Premises over and upon property now or formerly conveyed to Jerry R. Justice, of record in Deed Book 675, Page 431, in the Chatham County Registry, and being more particularly described as follows:

Granite Springs Road; COMMENCE at the Centerline Intersection of North Carolina Highway 87 and

Thence along a Chord Tie Line having a Bearing of S 69°34'37" E, a distance of 544.70 feet to the POINT OF BEGINNING;

Thence N 19°58'34" W, a distance of 100.00 feet;

Thence N 70°01'26" E, a distance of 100.00 feet;
Thence S 19°58'34" E, a distance of 100.00 feet;
Thence S 70°01'26" W, a distance of 100.00 feet to the POINT OF BEGINNING.

Said tract contains 0.23 Acres (10,000 Square Feet), more or less.

30' ACCESS & UTILITY EASEMENT

30' Access and Utility Easement over and upon property now or formerly conveyed to Jerry R. Justice, of record in Deed Book 675, Page 451, in the Chatham County Registry, and being more particularly described as follows: Situated in the Hadley Township, Chatham County, North Carolina. Being a Lessee's

Granite Springs Koad; COMMENCE at the Centerline Intersection of North Carolina Highway 87 and

\$44.70 feet to the POINT OF BEGINNING; Thence along a Chord Tie Line having a Bearing of S 69°34'37" E, a distance of

Thence N 19°58'34" W, a distance of 270.05 feet; Thence S 70°01'26" W, a distance of 30.00 feet;

Thence with a curve to the left with an arc length of 26.34 fect, with a radius of 35.00 feet, with a chord bearing of N 41°32'10" W, with a chord length of 25.72 feet;

Thence N 63°06'12" W, a distance of 92.84 feet;

Thence with a curve to the left with an arc length of 122.57 feet, with a radius of 185.00 feet, with a chord bearing of N 82°05′04" W, with a chord length of 120.34

Thence S 61°59'03" W, a distance of 59.30 feet to a point on the Centerline of Thence with a curve to the left with an arc length of 83.99 feet, with a radius of 283.91 feet, with a chord bearing of S 70°27'33" W, with a chord length of 83.68 feet; Thence S 78°56'03" W, a distance of 77.87 feet;

Thence N 31°12'03" W, along said Line, a distance of 30.05 feet;

Thence with a curve to the right with an arc length of 92.86 feet, with a radius of 313.91 feet, with a chord bearing of N 70°27'33" E, with a chord length of 92.53 feet; Thence N 61°59'03" E, leaving said Line, a distance of 60.97 feet;

Thence N 78°56'03" E, a distance of 77.87 feet;

Thence with a curve to the right with an arc length of 142.45 feet, with a radius of 215.00 feet, with a chord bearing of S 82°05′04″ E, with a chord length of 139.86 feet; Thence S 63°06'12" E, a distance of 92.84 feet;

Thence with a curve to the right with an arc length of 48.92 feet, with a radius of 65.00 feet, with a chord bearing of S 41°32'13" E, with a chord length of 47.77 feet. Thence S 19°58'34" E, a distance of 270.05 feet to the POINT OF BEGINNING.

Said tract contains 0.52 Acres (22,784 Square Feet), more or less.



TITLE EXAMINATION

(Surveyor's treatment of Title Examination Items is limited to the scope described in ALTA/NSPS 2016 requirements, Section 6. C. ii., and is limited to determination of the extent of land, that Title Items may influence, if any. Surveyor may indicate where review by Title Attorney may be warranted.)

No. 30327719, Issue Date: November 18, 2019: Reference: Report of Title, prepared by Fidelity National Title Insurance Company, Order

Item 1: Taxes, not addressed by Survey.

Item 2: Right of Way Easement to Southern Bell Telephone and Telegraph Company, Deed 552-999; Said Deed conveys 15' wide easement for Utilities East of Highway 87 Right of Way. Location of easement plotted and shown. Influences Parent Parcel & Lessee's Easement

Item 3: Right of Way Easement to Southern Bell Telephone and Telegraph Company, Deed 553-4: Same easement as Item 2 herein, but for other lands of Justice (Parcel C hereon).

of said Private Easement as shown hereon. Said Private Easement is described as "private": easement connects NC Highway 87 to the Southeast Corner of the property of Nunn, across the Parent Parcel. Influences Parent Parcel & Lessee's Easement (which runs within a portion and Rhonda L. Nunn (Parcel H hereon). A "30' Private Easement" is plotted and shown, this Item 4: Matters as shown on Plat Book 98-91; Said Plat depicts Boundary of Charles E. Nunr "Exclusivity" or Non-Exclusivity" is outside the scope of Survey analysis.

LEGAL DESCRIPTION OF PARENT PARCEL

particularly described as follows: Carolina and more Property located in Chatham County, North Carolina
All that certain lot or parcel of land situate in Hadley Township, Chatham County, North

Tract 1: All that certain tract or parcel of land containing 38 acres, more or less, and being all of the property described in Deed recorded in Book 270 at Page 91, Chatham County Registry, save and except 2.00 acres, more or less, conveyed to Don E. Bush.

dated March 18, 1998 and recorded April 3, 1998 in Deed Book 747, Page 700. LESS AND EXCEPT that portion of property conveyed to Rhonda L. Nunn and Charles E. Nunn from Jerry R. Justice and Anne C. Justice by North Carolina General Warranty Deed

September 29, 1995 in Deed Book 675, Page 451. AND BEING a portion of the same property conveyed to Jerry R. Justice from Elva W. Justice by North Carolina General Warranty Deed dated September 13, 1995 and recorded

Tax Parcel No. 0010843

NOTE: Record description is provided only for Parent Parcel, being Tract 1 of Deed 675-451. Said Deed conveys additional lands, (Tract 2, being Parcel C hereon, not addressed

270-91". Attention is directed to the fact that Page 91 of Deed Book 270 contains an additional, completely unrelated Deed that occupiles the first part of Page 91. The lands referenced in above description appeat to be those described in the Deed that begins on Page 91, and continues on Page 92 of said Book. NOTE: Record description describes property in terms of "property described in Deed



2857 Camp Creek Road Murphy, NC 28906 (828) 494-7058 NC License No: L-3037 Professional Land Surveyor DONALD L. CORDELL

PREPARED FOR

verizon

d/b/a/ Verizon Wireless CELLCO PARTNERSHIP

TOWER SITE SURVEY SITE NAME:

LUTTERLOH Location Code: 431701 NC Highway 87 North, Pittsboro, NC 27312

Hadley Township, Chatham County, North Carolina

SEE ISSUE LIST, SHEET NO 1 ISSUE DATE: 12-31-2019

ISSUE NO: 0

DRAWN BY: DLH CHECKED BY: TLS

APPROVED BY: DLC

DESCRIPTIONS SHEET 5 OF 5 SURVEYOR'S

LESSEE'S PREMISES:

Situated in the Hadley Township, Chatham County, North Carolina. Being a Lessee's Premises over and upon property now or formerly conveyed to Jerry R. Justice, of record in Deed Book 675, Page 451, in the Chatham County Registry, and being more particularly described as follows:

COMMENCE at the Centerline Intersection of North Carolina Highway 87 and Granite Springs Road; Thence along a Chord Tie Line having a Bearing of S 69°34'37" E, a distance of 544.70 feet to the POINT OF BEGINNING;

Thence N 19°58'34" W, a distance of 100.00 feet;

Thence N 70°01'26" E, a distance of 100.00 feet;

Thence S 19°58'34" E, a distance of 100.00 feet;

Thence S 70°01'26" W, a distance of 100.00 feet to the POINT OF BEGINNING.

Said tract contains 0.23 Acres (10,000 Square Feet), more or less.

LESSEE'S 30' ACCESS & UTILITY EASEMENT:

Situated in the Hadley Township, Chatham County, North Carolina. Being a Lessee's 30' Access and Utility Easement over and upon property now or formerly conveyed to Jerry R. Justice, of record in Deed Book 675, Page 451, in the Chatham County Registry, and being more particularly described as follows:

COMMENCE at the Centerline Intersection of North Carolina Highway 87 and Granite Springs Road; Thence along a Chord Tie Line having a Bearing of S 69°34'37" E, a distance of 544.70 feet to the POINT OF BEGINNING:

Thence S 70°01'26" W, a distance of 30.00 feet;

Thence N 19°58'34" W, a distance of 270.05 feet;

Thence with a curve to the left with an arc length of 26.34 feet, with a radius of 35.00 feet, with a chord bearing of N 41°32'10" W, with a chord length of 25.72 feet;

Thence N 63°06'12" W, a distance of 92.84 feet;

Thence with a curve to the left with an arc length of 122.57 feet, with a radius of 185.00 feet, with a chord bearing of N 82°05'04" W, with a chord length of 120.34 feet;

Thence S 78°56'03" W, a distance of 77.87 feet;

Thence with a curve to the left with an arc length of 83.99 feet, with a radius of 283.91 feet, with a chord bearing of \$70°27'33" W, with a chord length of 83.68 feet;

Thence S 61°59'03" W, a distance of 59.30 feet to a point on the Centerline of aforesaid Highway;

Thence N 31°12'03" W, along said Line, a distance of 30.05 feet;

Thence N 61°59'03" E, leaving said Line, a distance of 60.97 feet;

Thence with a curve to the right with an arc length of 92.86 feet, with a radius of 313.91 feet, with a chord bearing of N 70°27'33" E, with a chord length of 92.53 feet;

Thence N 78°56'03" E, a distance of 77.87 feet;

Thence with a curve to the right with an arc length of 142.45 feet, with a radius of 215.00 feet, with a chord bearing of S 82°05'04" E, with a chord length of 139.86 feet;

Thence S 63°06'12" E, a distance of 92.84 feet;

Thence with a curve to the right with an arc length of 48.92 feet, with a radius of 65.00 feet, with a chord bearing of S 41°32'13" E, with a chord length of 47.77 feet;

Thence S 19°58'34" E, a distance of 270.05 feet to the POINT OF BEGINNING.

Said tract contains 0.52 Acres (22,784 Square Feet), more or less.

Verizon-1430375-LutterlohLease1

Final Audit Report 2020-05-12

Created: 2020-05-11

By: Charika Huyler (Charika.Huyler@VerizonWireless.com)

Status: Signed

Transaction ID: CBJCHBCAABAAN7fhb7l9e2iCvxu_Flr_EpGolg_CnP9b

"Verizon-1430375-LutterlohLease1" History

Document created by Charika Huyler (Charika.Huyler@VerizonWireless.com) 2020-05-11 - 8:58:28 PM GMT- IP address: 137.188.108.201

Document emailed to Eric A. Mann (eric.mann@verizonwireless.com) for signature 2020-05-11 - 8:59:27 PM GMT

Email viewed by Eric A. Mann (eric.mann@verizonwireless.com) 2020-05-12 - 12:05:15 PM GMT- IP address: 74.125.209.26

Document e-signed by Eric A. Mann (eric.mann@verizonwireless.com)

Signature Date: 2020-05-12 - 12:05:41 PM GMT - Time Source: server- IP address: 69.78.66.89

Signed document emailed to ralph.gibbs@verizonwireless.com, Charika Huyler (Charika.Huyler@VerizonWireless.com), Eric A. Mann (eric.mann@verizonwireless.com), and Lee Taylor (Itaylor@bakerdonelson.com)

2020-05-12 - 12:05:41 PM GMT



8921 RESEARCH DRIVE CHARLOTTE, NC 28262

LUTTERLOH

SITE ADDRESS (E-911 VERIFIED)

0 NC 87 N PITTSBORO, NC 27312 CHATHAM COUNTY LATITUDE: 35° 47' 12.89" N LONGITUDE: 79° 14' 41.19" W

TAX/PIN #: AKPAR 10843 ZONING: RA

CHATHAM COUNTY SHERIFF'S DEPARTMENT 295 WEST STREET PITTSBORO, NC 27312 PHONE: (919) 542-2811 ATTN.: CUSTOMER SERVICE

CHATHAM COUNTY FIRE DEPARTMENT

150 SANFORD RD PITTSBORO. NC 27312 PHONE: (919) 542-4101 ATTN.: CUSTOMER SERVICE



FROM CHARLOTTE OFFICE: GET ON I-85 N FROM RESEARCH DR AND W W.T. HARRIS BLVD FOR 1.4 MI; FOLLOW I-85 AND US-421 S TO US-64 E IN CHATHAM COUNTY. TAKE EXIT 171 FROM US-421 S FOR 107 MI; TURN LEFT ONTO US-64 E FOR 12.9 MI; TAKE EXIT 381 FOR NC-87 N TOWARD BURLINGTON FOR 0.3 MI; TURN LEFT ONTO NC-87 N FOR 3.9 MI; THEN THE DESTINATION WILL BE ON THE RIGHT.

DRIVING DIRECTIONS

JURISDICTION: CHATHAM COUNTY

STATE: NORTH CAROLINA

TOWER TYPE: SELF-SUPPORT TOWER

TOWER HEIGHT: 255' (264' TO HIGHEST APPURTENANCE)

NUMBER OF CARRIERS: 0 EXISTING, 1 PROPOSED

USE:

PROPOSED TELECOMMUNICATIONS TOWER AND UNMANNED EQUIPMENT

FLOOD INFO

SITE IS LOCATED WITHIN FEMA FLOOD MAP AREA 3710972400K DATED 11/17/2017 WITHIN FLOOD ZONE X.

PROJECT SUMMARY

DEVELOPER
VERIZON WIRELESS
8921 RESEARCH DRIVE
CHARLOTTE, NC 28262
PHONE: (704) 577-8785
ATTN: MICHAEL HAVEN

POWER COMPANY
DUKE ENERGY PROGRESS
PHONE: (800) 452-2777
ATTN.: CUSTOMER SERVICE

PROPERTY OWNER
JERRY R. JUSTICE
2654 NC HIGHWAY 87 NORTH
PITTSBORO, NC 27312
PHONE: (919) 755-4914
ATTN.: JERRY JUSTICE

CONSULTANT

KIMLEY-HORN AND ASSOCIATES, INC. 11720 AMBER PARK DRIVE, SUITE 600 ALPHARETTA, GEORGIA 30009 PHONE: (770) 545-6105 ATTN.: DAVID FRANKLIN

CONTACTS

SHEET NO. SHEET TITLE COVER SHEET T1 APPENDIX B - BUILDING CODE SUMMARY T2 SITE SURVEY (SHEET 1 OF 5) SITE SURVEY (SHEET 2 OF 5) SITE SURVEY (SHEET 3 OF 5) SITE SURVEY (SHEET 4 OF 5) SITE SURVEY (SHEET 5 OF 5) N1 GENERAL NOTES C0 **OVERALL PARCEL** C1 OVERALL SITE PLAN C2 SITE PLAN EQUIPMENT PAD LAYOUT C3 EQUIPMENT RACK DETAIL - FRONT C4 C5 EQUIPMENT RACK DETAIL - REAR CONCRETE PAD FOUNDATION DETAILS C6 FENCE, GATE, AND COMPOUND DETAILS C7 GRADING AND EROSION CONTROL PLAN C8 C9 GRADING AND EROSION CONTROL DETAILS C10 ACCESS ROAD DETAILS C11 SITE SIGNAGE DETAILS C12 WAVEGUIDE BRIDGE DETAILS C13 ANTENNA AND TOWER ELEVATION DETAILS LANDSCAPING PLAN L1 E1 **ELECTRICAL NOTES** E2 UTILITY SERVICE ROUTING PLAN OVERALL UTILITY ROUTING PLAN E3 E4 METER RACK DETAILS - FRONT E4.1 METER RACK DETAILS - REAR E5 ELECTRICAL SINGLE LINE DIAGRAM E5.1 ELECTRICAL SINGLE LINE DIAGRAM E6 PANEL SCHEDULE E7 ELECTRICAL DETAILS E8 **GROUNDING NOTES** E9 GROUNDING PLAN GROUNDING SINGLE LINE DIAGRAM E10 E11 **GROUNDING DETAILS** GROUNDING DETAILS E12 SHEET INDEX

CHATHAM COUNTY PLANNING

80 EAST ST A

PITTSBORO, NC 27312 PHONE: (919) 542-8204 ATTN.: CUSTOMER SERVICE

PERMIT INFORMATION

verizon

CHARLOTTE, NORTH CAROLINA 28


SITE NAME: LUTTERLOH SITE No.: 431701 PROJECT #: 20192010936 0 NC 87 N PITTSBORO, NC 27312 CHATHAM COUNTY

PLANS PREPARED BY:

PROJECT INFORMATION:


Kimley Whorr

11720 AMBER PARK DRIVE, SUITE 600 ALPHARETTA, GA 30009 PHONE: 770-619-4280 WWW.KIMLEY-HORN.COM NC. License F-0102

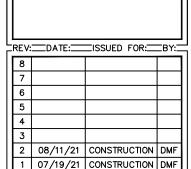

0 07/12/21 CONSTRUCTION DMF

LICENSER:

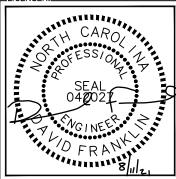

KHA PROJECT NUMBER:

013509278 __DRAWN_BY:______CHECKED_BY:___

DRAWN BY: CHECKED BY

SHEET TITLE:

COVER SHEET

SHEET NUMBER:

T1

right Kimley-Horn and Associates Inc. 2021

| | | | | 1 |
|--|--|--|--|--|
| 2018 APPENDIX B | Frontage area increases from Section 506.2 are computed thus: a. Perimeter which fronts a public way or open space having 20 feet minimum width = | ACCESSIBLE DWELLING UNITS (SECTION 1107) TOTAL ACCESSIBLE ACCESSIBLE TYPE A UNITS UNITS UNITS UNITS UNITS UNITS UNITS PROVIDED PROVIDED PROVIDED PROVIDED ACCESSIBLE PARKING (SECTION 1106) | 2018 APPENDIX B BUILDING CODE SUMMARY FOR ALL COMMERCIAL PROJECTS STRUCTURAL DESIGN (PROVIDE ON THE STRUCTURAL SHEETS IF APPLICABLE) DESIGN LOADS: Importance Factors: Snow (Is) | CHARLOTT PROJECT INF |
| CONTACT: DAVID FRANKLIN, P.E. (#042027) | Building Height in Feet (Table 5040) Building Height in Stories and bis 504.4) 1 Provide code reference if the "Shown on Plans" quantity is not based on Table 504.3 or 504.4. FIRE PROTECTION REQUIREMENTS BUILDING ELEMENT FIRE SEPARATION SEPARATION REQ'D PROVIDED AND FOR RATED PRETENTION RATED PRETENTION RATED NISTANCE | LOT OR PARKING TOTAL # OF PARKING SPACES REQUIRED PROVIDED REGULAR WITH VANOVACES WITH ACCESSIBLE S'ACCESS AISLE TOTAL PLUMBING FIXTURE REQUIREMENTS (TABLE 2902.1) USE WATERCLOSETS ORNALS LAVATORIES SHOWER DRINKING FOUNTAINS | Mezzanine | PLANS PREPA |
| 2018 NC BUILDING CODE: New Building Addition Renovation 1st Time Interior Completion Shell/Core - Contact the local inspection jurisdiction for possible additional procedures and requirements Phased Construction - Shell/Core - Contact the local inspection jurisdiction for possible additional procedures and requirements 2018 NC EXISTING BUILDING CODE: EXISTING: Prescriptive Repair Chapter 14 Alteration: Level II Level III Level III Level III Level III CONSTRUCTED: (date) CURRENT OCCUPANCY(S) (Ch. 3): TELECOMMUNICATIONS STE RENOVATED: (date) PROPOSED OCCUPANCY(S) (Ch. 3): TELECOMMUNICATIONS STE RISK CATEGORY (Table 1604-5): Current: 1 III III III IV | Structural Frame, including columns, girders, trustes Bearing Walls Exterior East West South Interior Interior Interior East Exterior Exterior Exterior Exterior Exterior walls Exterior walls | SPACE EXIST'G MALE FEMALE UNSEX MALE FEMALE UNSEX TUSS REGULAR ACCESSIBLE NEW REQ'D SPECIAL APPROVALS SPECIAL APPROVALS Special approval: Local Jurisdiction, Department of Insurance, OSC, DPI, DHHS, etc., describe below) | Data Source: | ALPP PHOI WWW NC |
| | East West South Interior walls and pastitions Floor Construction Including supporting beams and joists Floor Ceiling Assembly Columns Supporting Floors Roof Construction, including supporting beams and joists Roof Colling Assembly Columns Supporting Roof South Roof Colling Assembly Columns Supporting Roof Shift Enclosures - Exit | ENERGY SUMMARY ENERGY REQUIREMENTS: The following data shall be considered minimum and any special attribute required to meet the energy code shall also be provided. Each Designer shall furnish the required portions of the project information for the plan data sheet. If performance method, state the annual energy cost for the standard reference design vs annual energy cost for the proposed design. Existing building envelope complies with code: No Yes (The remainder of this section) not applicable) Exempt Building: No Yes (Provide code or statutory reference): Climate Zone: 3A 4A 5A | 2018 APPENDIX B BUILDING CODE SUMMARY FOR ALL COMMERCIAL PROJECTS MECHANICAL DESIGN (PROVIDE ON THE MECHANICAL SHEETS IF APPLICABLE) MECHANICAL SUMMARY MECHANICAL SYSTEMS, SERVICE SYSTEMS AND EQUIPMENT Thermal Zone winter dry bulb: | REV:DATE:: |
| FLOOR EXISTING (SQ FT) NEW (SQ FT) SUB-TOTAL 3rd Floor Mezzanine 1st Floor Basement TOTAL ALLOWABLE AREA Primary Occupancy Classification(s): Select one Selec | Shaft Enclosures - Other Corridor Separation Occupancy/Fire Barrier Sept ation Party/Fire Wall Separation Smoke Barrier Sept ation Tenant/Dwelling Units' Sleeping Ling Separation Incidental/Ose Separation Indicate section number permitting reduction | Method of Compliance: Energy Code | Interior design conditions winter dry bulb: summer dry bulb: relative humidity: Building heating load: Building cooling load: Mechanical Spacing Conditioning System Unitary description of unit: heating officiency: | 7 6 5 4 3 2 08/11/2 1 07/19/2 0 07/12/2 |
| Educational | PERCENTAGE OF WALL OPENING CALCULATIONS FIRE SEPARATION DISTANCE (FEET) FROM PROPERTY LINES PROTECTION (TABLE 705.8) LIFE SAFETY SYSTEM REQUIREMENTS Emergency Lighting: No Yes Exit Signs: No Yes | Exterior Walls (each assembly: U-Value of total assembly: R-Value of insulation: Openings (windows or doors rith glazing) U-Value of assembly: Solar heat gain of efficient: projection facts: Door R-Value's: Walls below grade (each assembly) Description of assembly: U-Value of grad assembly: R-Value of malasembly: R-Value of malasembly: R-Value of malasembly: | cooling efficiency: size aftegory of unit: Boils Size category. If oversized, state reason.: chiller Size category. If oversized, state reason.: List equipment efficiencies: 2018 APPENDIX B BUILDING CODE SUMMARY FOR ALL COMMERCIAL PROJECTS ELECTRICAL DESIGN | LICENSER: |
| Accessory Occupancy Classification(s): Incidental Uses (Table 509): Special Provisions: (Chapter 4 – List Code Sections): Special Provisions: (Chapter 5 – List Code Sections): Mixed Occupancy: Non-Separated Use (508.3) - The required type of construction for the building shall be determined by applying the height and area limitations for each of the applicable occupances to the entire building. The most restrictive type of construction, so determined, shall apply to the entire building. Separated Use (508.4) - See below for area calculations for each story, the area of the occupancy shall be such that the sum of the ratios of the actual floor area of each use divided by the flowable floor area for each use shall not exceed 1. Actual Area of Occupancy A + Actual Area of Occupancy B 1 | Fire Alarm: | Floors over uponditioned space (each assembly) Description of assembly: UValue of total assembly: E-Value of insulation: Floors slab on grade Description of assembly: U-Value of total assembly: H-Value of total assembly: R-Value of insulation: Horizontal/vertical requirement: slab heated: | CPROVIDE ON THE ELECTRICAL SHEETS IF APPLICABLE | KHA PROJECT |
| Allowable Area of Occupancy A Allowable Area of Occupancy B + + = < 1.00 STORY DESCRIPTION AND (A) NO. ASE BLDG AREA PER TABLE 506.2 ⁴ AREA FOR PRONTAGE ALLOWABLE AREA PER STORY (ACTUAL) AREA INCREASE ^{1,5} STORY OR UNLIMITED ^{2,3} | Exit access travel distances (1017) Common path of travel distances (Tooles 1006.2.1 & 1006.3.2(1)) Dead end lengths (1020.4) Clear exit widths for each exit door Maximum calculated occupant load capacity each exit door can accommodate based on egress width (1005.3) Actual occupant load for each exit door A separate schematic flan indicating where fire rated floor/ceiling and/or roof structure is provided for purposes of occupancy separation Location of doorf with panic hardware (1010.1.10) Location of doorf with panic hardware (1010.1.10) Location of doors with delayed egress locks and the amount of delay (1010.1.9.7) Location of doors with electromagnetic egress locks (1010.1.9.9) Location of doors equipped with hold-open devices Location of doors equipped with hold-open devices Location of doors devices experiments (1030) The square flootage of each fire area (202) The square flootage of each moke compartment for Occupancy Classification 1-2 (407.5) Note any code exerctions or table notes that may have been utilized reparding the items above | NOTE: SCOPE OF WORK INCLUDES INSTALLATION OF CAST IN PLACE CONCRETE PAD, PREFABRICATED EQUIPMENT CABINETS AND GENERATOR. NO NEW BUILDING BEING CONSTRUCTED. | total wattage per fixture total interior wattage specific ivs. allowed (whole building or space by space) total exterior wattage specified vs. allowed Additional Efficiency Payinge Options (When using the 2018) CECC; not required for ASHRAE 90.1) C406.2 More Efficient HVAC Equipment Performance C406.3 Reduced Lighting Power Density 606.4 Enhanced Digital Lighting Controls C406.5 On-Site Renewable Energy C406.6 Dedicated Outdoor Air System C406.7 Reduced Energy Use in Service Water Heating | SHEET NUMB |

verizon/

8921 RESEARCH DRIVE CHARLOTTE, NORTH CAROLINA 28262

ROJECT INFORMATION:


SITE NAME: LUTTERLOH SITE No.: 431701 PROJECT #: 20192010936 0 NC 87 N PITTSBORO, NC 27312 CHATHAM COUNTY

LANS PREPARED BY:



11720 AMBER PARK DRIVE, SUITE 600 ALPHARETTA, GA 30009 PHONE: 770-619-4280 WWW.KIMLEY-HORN.COM NC License F-0102

V:__DATE:___ISSUED FOR:__BY: 08/11/21 CONSTRUCTION DMF 07/19/21 CONSTRUCTION DMF 07/12/21 CONSTRUCTION DMF

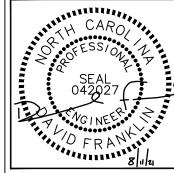

HA PROJECT NUMBER:

013509278

RAWN BY: CHECKED BY:

HEET TITLE:

APPENDIX B -

BUILDING CODE SUMMARY

HEET NUMBER:

T2


SURVEYOR'S NOTES:

- NORTH ORIENTATION: North Carolina State Plane Coordinate System, NAD 83 (CORS), determined by GPS Survey
- ELEVATION DATUM: NAVD88, relative to Continuously Operating Reference Station (CORS) Benchmark as noted hereon. Onsite benchmark is as shown
- This is a Tower Site Survey, made on the ground under the supervision of a Registered Land Surveyor. Date of field survey is 12-03-2019
- Instruments Used: Topcon GTS 212 and Prism, Topcon Hiperlite Plus GPS, TDS Nomad and/or Carlson Surveyor Data Collector.
- Surveyor hereby states the Geodetic Coordinates and the elevation shown for the centerline of the tower are accurate to within ± 15 feet horizontally and to within ± 3 feet vertically (FAA Accuracy Code 1A).
- Survey shown hereon conforms to the Minimum Requirements as set forth by the State Board for a Class B Survey. Field traverse did not require adjustment.
- Improvements (Utilities, Buildings, Trees, Fences, etc) not located, unless specifically shown hereon in the vicinity of surveyed property.
- No underground utilities, underground encroachments or building foundations were measured or located as a part of this survey, unless otherwise shown.
- This survey was conducted for the purpose of a Tower Site Survey only, and is not intended to delineate the regulatory jurisdiction of any federal, state, regional or local agency, board, commission or other similar entity. Survey as published is not intended to be suitable for recording as a Subdivision Plat
- Attention is directed to the fact that this survey may have been reduced or enlarged in size due to reproduction. This should be taken into consideration when obtaining scaled data.
- 11. This survey is not valid without the original signature and the original seal of a State-Licensed Land Surveyor, and is not complete without all sheets.
- 12. This survey does not constitute a complete boundary survey of the Parent Tract, or adjoining Parcels.
- Title Examination was available at time of Survey.
- 14. FLOOD ZONE DATA: By graphic plotting only, Lessee's Premises and Easement(s) appear to lie within ZONE "X" per F.E.M.A Flood Insurance Rate Map Community Panel No.3710972400K dated 11/17/20017. Zone X: Areas of Minimal Flood Hazard

SURVEYOR'S CERTIFICATION:

To: Cellco Partnership, d/b/a/ Verizon Wirelss:

I, Donald Cordell, certify that this project was completed under my direct and responsible charge from an actual Ground Survey made under my supervision.

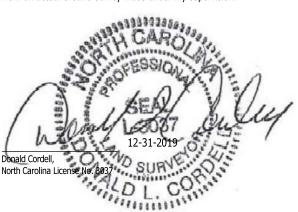

PROPOSED TOWER DATA


35° 47' 12.89" NORTH Latitude: Longitude: 79° 14' 41.19" WEST

Ground Elevation: 484.0 feet AMSL NAVD88

CORS Benchmark: DL3891 NCJL

SURVEY RELEASE DATA

| | # | DETAILS | DATE | DRAWN | APP |
|---|---|-----------------------|------------|-------|-----|
| Ī | 0 | Original Survey Issue | 12-31-2019 | DLH | DLC |

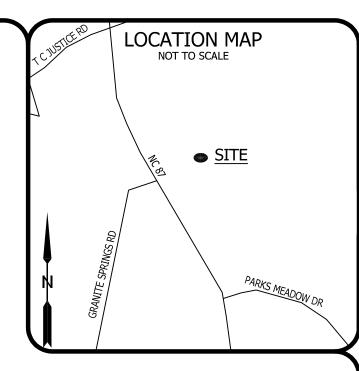





DONALD L. CORDELL

2857 Camp Creek Road Murphy, NC 28906 (828) 494-7058 NC License No: L-3037

PREPARED FOR



CELLCO PARTNERSHIP d/b/a/ Verizon Wireless

LEGEND

Ø UTILITY POLE

TI TELECOM JUNCTION

R/W, ROW RIGHT-OF-WAY ACCESS/UTILITY ΑU ESMT EASEMENT

POC POINT OF COMMENCEMENT POB POINT OF BEGINNING Sa Ft SQUARE FEET

LESSEE'S PREMISES

PAVEMENT EDGE UNPAVED ROAD EDGE = = = = = Stormwater Pipe - 5' CONTOURS ----1' CONTOURS — TAX PARCEL BOUNDARY · - - ---- EXISTING EASEMENT — ACCESS/UTILITY ESMT

SURVEY SIT TOWER

431701 Pittsboro, 87 NC Highway County, North Carolina

Chatham

Township,

27312

ISSUE NO: 0

ISSUE DATE: 12-31-2019 SEE ISSUE LIST, SHEET NO 1

DRAWN BY: DLH CHECKED BY: TLS APPROVED BY: DLC

COVER SHEET

SHEET 1 OF 5

PROPERTY INFORMATION

PARENT PARCEL

A. JERRY R. JUSTICE TAX PARCEL: 0010843 DEED BOOK 675, PAGE 451


ADJOINING TAX PARCELS

- B. LARRY F. JUSTICE HEIRS TAX PARCEL: 0010862 DEED BOOK 675, PAGE 463
- C. JERRY R. JUSTICE TAX PARCEL: 0010876 DEED BOOK 675, PAGE 451
- D. SHERRILL LINDLEY ...
 TAX PARCEL: 0061957
 DEED BOOK 499, PAGE 542
- E. GREGORY OLIVER ...
 TAX PARCEL: 0010818
 DEED BOOK 1891, PAGE 296
 PLAT BOOK 2003, PAGE 213
- F. MICHAEL EDWARD STANO TR TAX PARCEL: 0080649 DEED BOOK 2031, PAGE 0055 PLAT BOOK 2003, PAGE 213
- G. KITTRELL ANNE DESBON TAX PARCEL: 0080648 DEED BOOK 1812, PAGE 980 PLAT BOOK 2003, PAGE 213
- H. RHONDA L. NUNN
 CHARLES E. NUNN
 TAX PARCEL: 0074285
 DEED BOOK 747, PAGE 700
 PLAT BOOK 98, PAGE 91

SURVEY & MAP CAVEATS:

Surveyed Data is as shown on Survey Map Sheets herein.

This is not a Boundary Survey of Parent Tax Parcel or adjoiners. Parent Parcel Property lines are shown based on Tax Map Data, Plats and/or Daeds

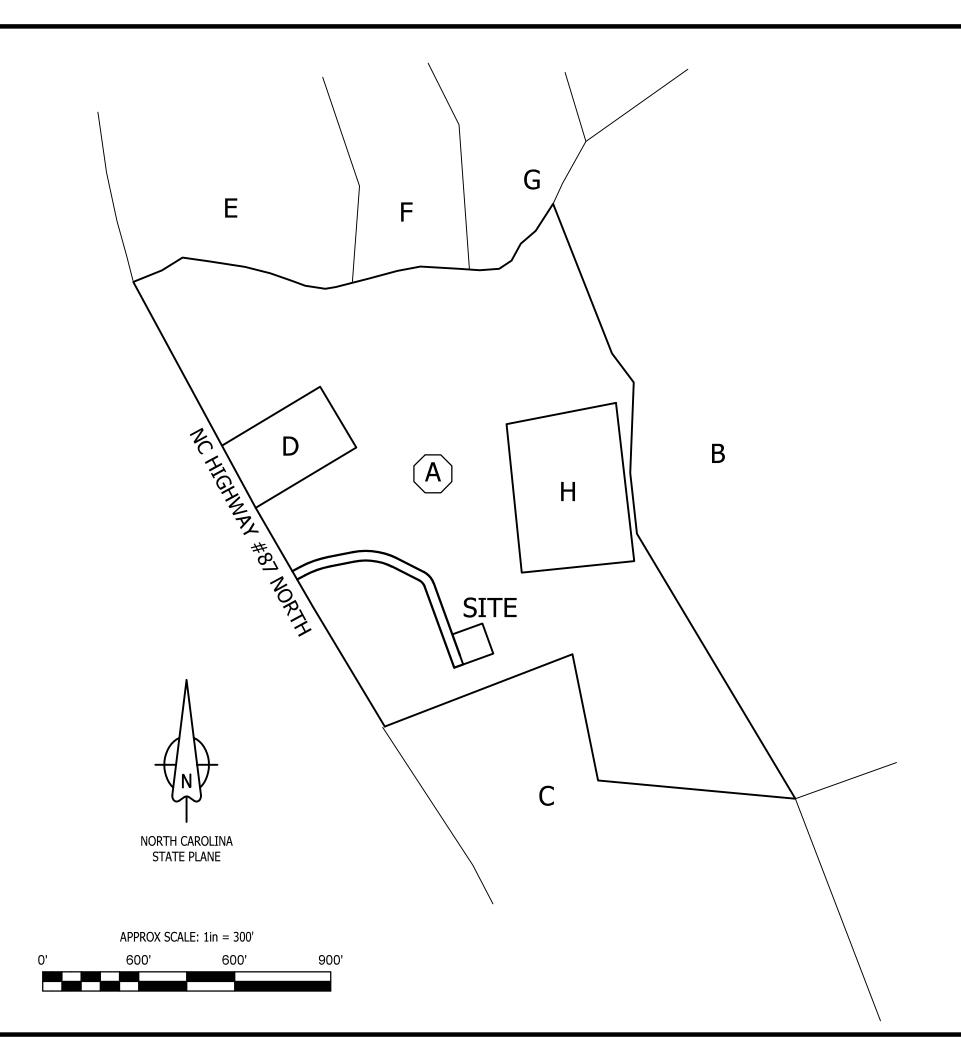





DONALD L. CORDELL

Professional Land Surveyor

2857 Camp Creek Road Murphy, NC 28906 (828) 494-7058 NC License No: L-3037

PREPARED FOR



CELLCO PARTNERSHIP d/b/a/ Verizon Wireless

d/b/a/ Verizon Wireles

LUTTERLOH
Location Code: 431701
NC Highway 87 North, Pittsboro, NC 27312

Chatham County, North Carolina

Township,

Hadley [·]

ISSUE NO: 0

SURVEY

SITE


TOWER


ISSUE DATE: 12-31-2019 SEE ISSUE LIST, SHEET NO 1

DRAWN BY: DLH CHECKED BY: TLS APPROVED BY: DLC

OVERVIEW

SHEET 2 OF 5

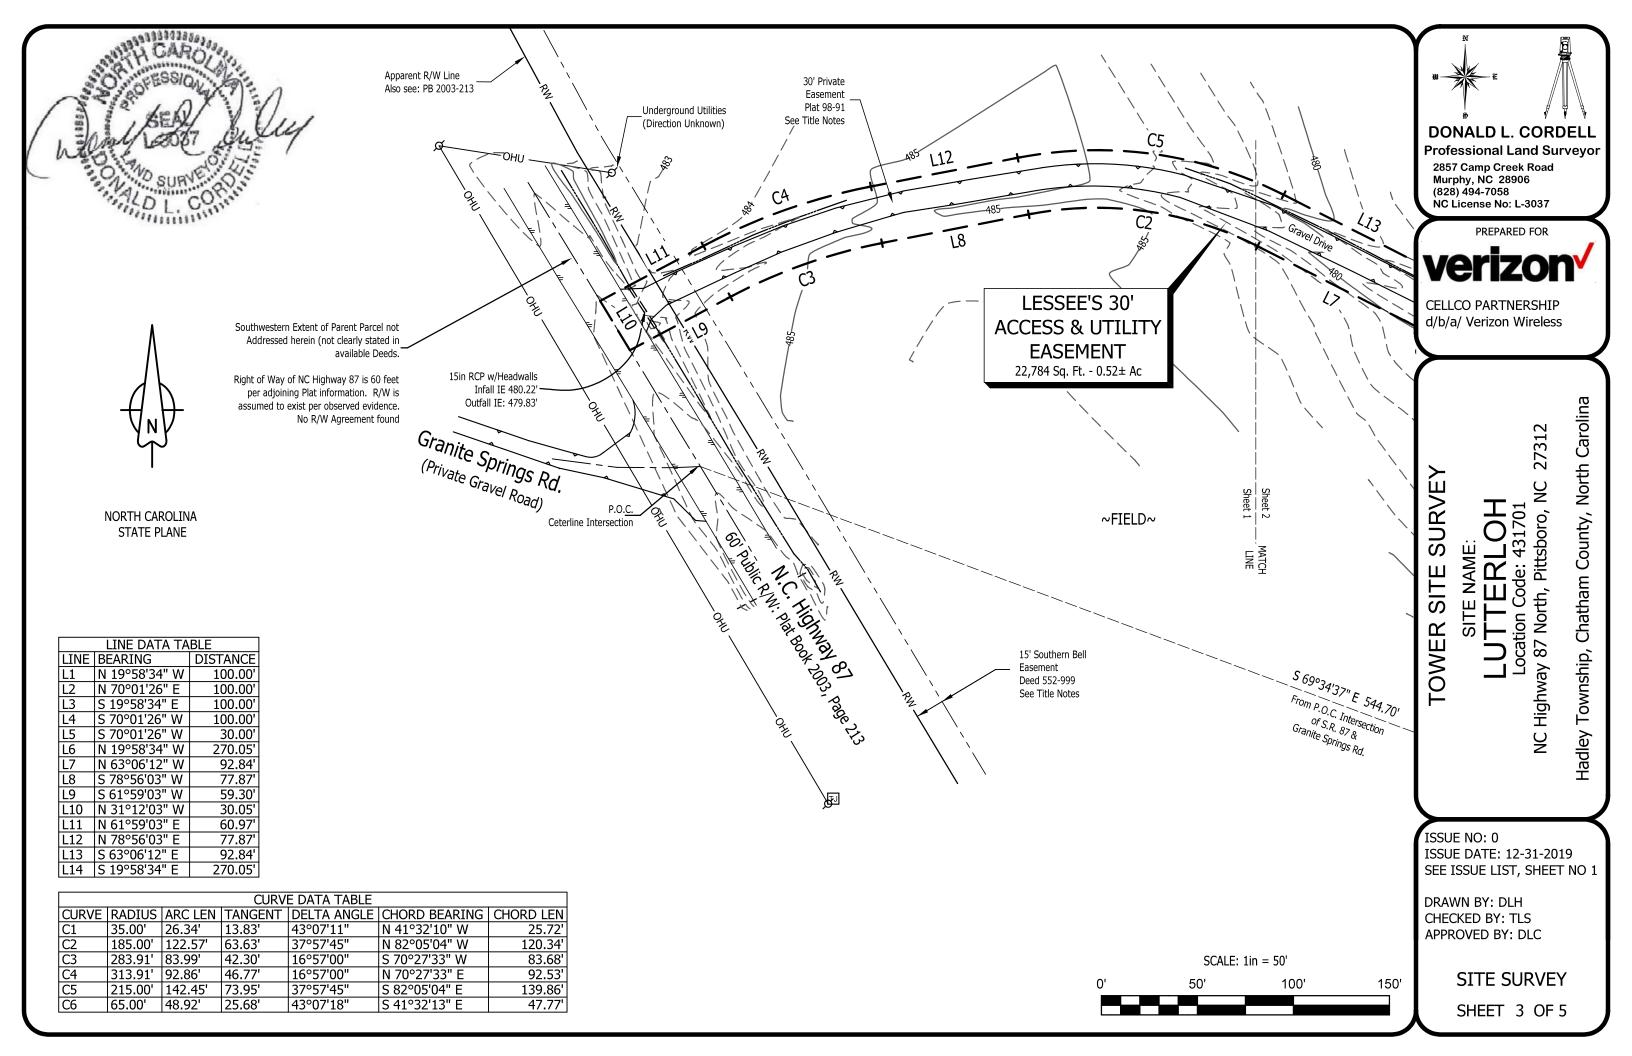

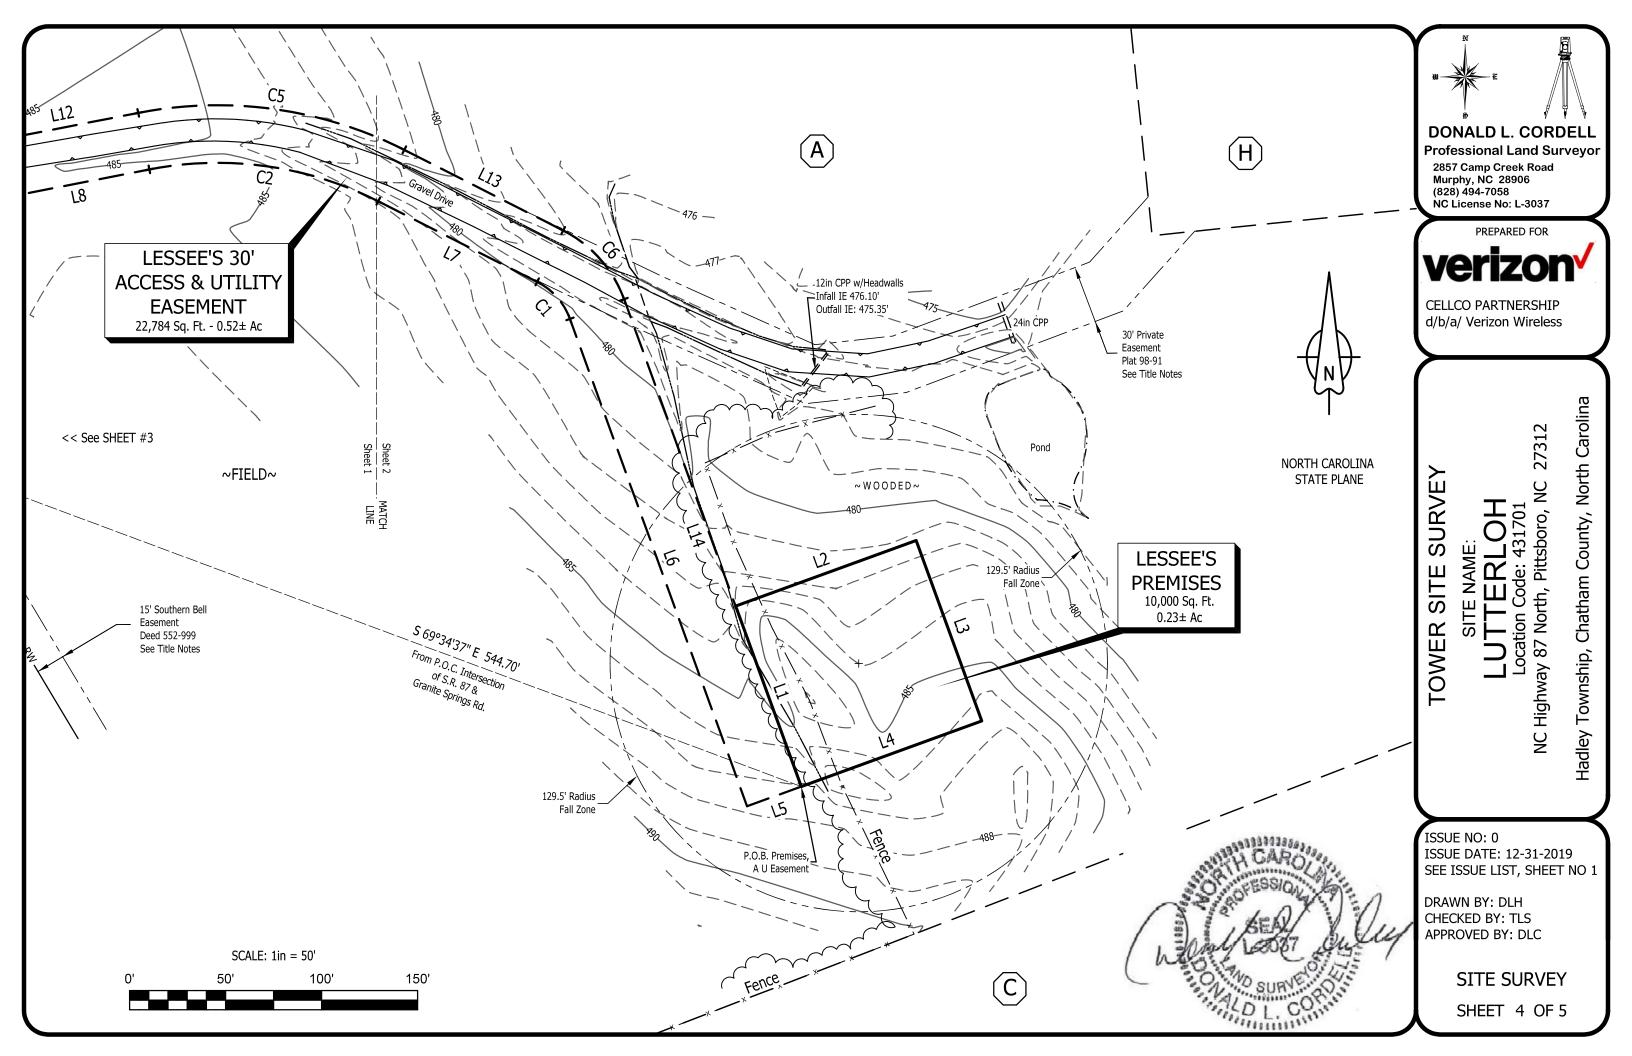

LESSEE'S PREMISES

Situated in the Hadley Township, Chatham County, North Carolina. Being a Lessee's Premises over and upon property now or formerly conveyed to Jerry R. Justice, of record in Deed Book 675, Page 451, in the Chatham County Registry, and being more particularly described as follows:

COMMENCE at the Centerline Intersection of North Carolina Highway 87 and Granite Springs Road;

Thence along a Chord Tie Line having a Bearing of S 69°34'37" E, a distance of 544.70 feet to the POINT OF BEGINNING;

Thence N 19°58'34" W, a distance of 100.00 feet;

Thence N 70°01'26" E, a distance of 100.00 feet;

Thence S 19°58'34" E, a distance of 100.00 feet;

Thence S 70°01'26" W, a distance of 100.00 feet to the POINT OF BEGINNING.

Said tract contains 0.23 Acres (10,000 Square Feet), more or less.

LESSEE'S 30' ACCESS & UTILITY EASEMENT

Situated in the Hadley Township, Chatham County, North Carolina. Being a Lessee's 30' Access and Utility Easement over and upon property now or formerly conveyed to Jerry R. Justice, of record in Deed Book 675, Page 451, in the Chatham County Registry, and being more particularly described as follows:

COMMENCE at the Centerline Intersection of North Carolina Highway 87 and Granite Springs Road;

Thence along a Chord Tie Line having a Bearing of S 69°34'37" E, a distance of 544.70 feet to the POINT OF BEGINNING:

Thence S 70°01'26" W, a distance of 30.00 feet:

Thence N 19°58'34" W, a distance of 270.05 feet;

Thence with a curve to the left with an arc length of 26.34 feet, with a radius of 35.00 feet, with a chord bearing of N 41°32'10" W, with a chord length of 25.72 feet;

Thence N 63°06'12" W, a distance of 92.84 feet;

Thence with a curve to the left with an arc length of 122.57 feet, with a radius of 185.00 feet, with a chord bearing of N 82°05'04" W, with a chord length of 120.34 feet:

Thence S 78°56'03" W, a distance of 77.87 feet;

Thence with a curve to the left with an arc length of 83.99 feet, with a radius of 283.91 feet, with a chord bearing of S 70°27'33" W, with a chord length of 83.68 feet; Thence S 61°59'03" W, a distance of 59.30 feet to a point on the Centerline of aforesaid Highway;

Thence N 31°12'03" W, along said Line, a distance of 30.05 feet;

Thence N 61°59'03" E, leaving said Line, a distance of 60.97 feet;

Thence with a curve to the right with an arc length of 92.86 feet, with a radius of 313.91 feet, with a chord bearing of N 70°27'33" E, with a chord length of 92.53 feet; Thence N 78°56'03" E, a distance of 77.87 feet;

Thence with a curve to the right with an arc length of 142.45 feet, with a radius of 215.00 feet, with a chord bearing of S 82°05'04" E, with a chord length of 139.86 feet; Thence S 63°06'12" E, a distance of 92.84 feet;

Thence with a curve to the right with an arc length of 48.92 feet, with a radius of 65.00 feet, with a chord bearing of S 41°32'13" E, with a chord length of 47.77 feet; Thence S 19°58'34" E, a distance of 270.05 feet to the POINT OF BEGINNING.

Said tract contains 0.52 Acres (22,784 Square Feet), more or less.



TITLE EXAMINATION

(Surveyor's treatment of Title Examination Items is limited to the scope described in ALTA/NSPS 2016 requirements, Section 6. C. ii., and is limited to determination of the extent of land, that Title Items may influence, if any. Surveyor may indicate where review by Title Attorney may be warranted.)

Reference: Report of Title, prepared by Fidelity National Title Insurance Company, Order No. 30327719, Issue Date: November 18, 2019:

Item 1: Taxes, not addressed by Survey.

Item 2: Right of Way Easement to Southern Bell Telephone and Telegraph Company, Deed 552-999: Said Deed conveys 15' wide easement for Utilities East of Highway 87 Right of Way. Location of easement plotted and shown. Influences Parent Parcel & Lessee's Easement as shown.

Item 3: Right of Way Easement to Southern Bell Telephone and Telegraph Company, Deed 553-4: Same easement as Item 2 herein, but for other lands of Justice (Parcel C hereon).

Item 4: Matters as shown on Plat Book 98-91; Said Plat depicts Boundary of Charles E. Nunn and Rhonda L. Nunn (Parcel H hereon). A "30' Private Easement" is plotted and shown, this easement connects NC Highway 87 to the Southeast Corner of the property of Nunn, across the Parent Parcel. Influences Parent Parcel & Lessee's Easement (which runs within a portion of said Private Easement as shown hereon. Said Private Easement is described as "private": "Exclusivity" or Non-Exclusivity" is outside the scope of Survey analysis.

LEGAL DESCRIPTION OF PARENT PARCEL

Property located in Chatham County, North Carolina
All that certain lot or parcel of land situate in Hadley Township, Chatham County, North
Carolina and more
particularly described as follows:

Tract 1: All that certain tract or parcel of land containing 38 acres, more or less, and being all of the property described in Deed recorded in Book 270 at Page 91, Chatham County Registry, save and except 2.00 acres, more or less, conveyed to Don E. Bush.

LESS AND EXCEPT that portion of property conveyed to Rhonda L. Nunn and Charles E. Nunn from Jerry R. Justice and Anne C. Justice by North Carolina General Warranty Deed dated March 18, 1998 and recorded April 3, 1998 in Deed Book 747, Page 700.

AND BEING a portion of the same property conveyed to Jerry R. Justice from Elva W. Justice by North Carolina General Warranty Deed dated September 13, 1995 and recorded September 29, 1995 in Deed Book 675, Page 451.

Tax Parcel No. 0010843

NOTE: Record description is provided only for Parent Parcel, being Tract 1 of Deed 675-451. Said Deed conveys additional lands, (Tract 2, being Parcel C hereon, not addressed by Survey).

NOTE: Record description describes property in terms of "property described in Deed 270-91". Attention is directed to the fact that Page 91 of Deed Book 270 contains an additional, completely unrelated Deed that occuplies the first part of Page 91. The lands referenced in above description appear to be those described in the Deed that begins on Page 91, and continues on Page 92 of said Book.





DONALD L. CORDELL
Professional Land Surveyor

2857 Camp Creek Road Murphy, NC 28906 (828) 494-7058 NC License No: L-3037

PREPARED FOR



CELLCO PARTNERSHIP d/b/a/ Verizon Wireless

SITE NAME:

LUTTERLOH

Location Code: 431701

NC Highway 87 North, Pittsboro, NC 27312

SURVEY

SITE

TOWER

Chatham County, North Carolina

, Township, (

Hadley .

ISSUE NO: 0

ISSUE DATE: 12-31-2019 SEE ISSUE LIST, SHEET NO 1

DRAWN BY: DLH CHECKED BY: TLS APPROVED BY: DLC

> SURVEYOR'S DESCRIPTIONS SHEET 5 OF 5

1.00 GENERAL NOTES

- 1.01 ALL MATERIALS AND WORKMANSHIP SHALL CONFORM TO THE DRAWINGS AND SPECIFICATIONS. ALL WORK SHALL BE DONE IN ACCORDANCE WITH THE LATEST EDITION OF THE STATE, LOCAL AND NATIONAL CODES, ORDINANCES AND OR REGULATIONS APPLICABLE TO THIS PROJECT.
- 1.02 THE CONTRACTOR SHALL BE RESPONSIBLE FOR COORDINATING THE WORK OF ALL TRADES AND SHALL CHECK ALL DIMENSIONS. ALL DISCREPANCIES SHALL BE CALLED TO THE ATTENTION OF THE PROJECT MANAGER AND/OR ENGINEER AND BE RESOLVED BEFORE PROCEDING WITH WORK. WHERE THERE IS A CONFLICT BETWEEN DRAWING AND VERIZON SPECIFICATIONS, THE VERIZON PROJECT ENGINEER SHOULD BE CONTACTED FOR CLARIFICATION.
- 1.03 ALL INFORMATION SHOWN ON THE DRAWINGS RELATIVE TO EXISTING CONDITIONS IS GIVEN AS THE BEST PRESENT KNOWLEDGE, BUT WITHOUT GUARANTEE OF ACCURACY. WHERE ACTUAL CONDITIONS CONFLICT WITH THE DRAWINGS, THEY SHALL BE REPORTED TO THE PROJECT MANAGER AND/OR ENGINEER SO THAT PROPER REVISIONS MAY BE MADE. MODIFICATION OF DETAILS OF CONSTRUCTION SHALL NOT BE MADE WITHOUT WRITTEN APPROVAL OF THE PROJECT MANAGER AND/OR ENGINEER.
- 1.04 CONTRACTOR SHALL REVIEW AND BE FAMILIAR WITH SITE CONDITIONS AS SHOWN ON THE ATTACHED SITE PLAN AND/OR SURVEY DRAWINGS.
- 1.05 WAVEGUIDE BRIDGE AND EQUIPMENT CABINETS ARE SHOWN FOR REFERENCE ONLY. REFER TO SEPARATE DRAWINGS FOR SPECIFIC INFORMATION
- 1.06 ALL FINISHED GRADES SHALL SLOPE MINIMUM 1/4 IN./FT. AWAY FROM EQUIPMENT IN ALL DIRECTIONS. CONTRACTOR SHALL SLOPE SWALES AS REQUIRED ALONG EXISTING TERRAIN TO DRAIN AWAY FROM COMPOUND AND ACCESS DRIVE.
- 1.07 THE PROPOSED TOWER AND TOWER FOUNDATIONS WERE DESIGNED BY OTHERS. TOWER INFORMATION PROVIDED ON THESE PLANS ARE PROVIDED FOR REFERENCE PURPOSES ONLY. NOTIFY ENGINEER OR PROJECT MANAGER OF ANY CONFLICTS OR DISCREPANCIES. CONTRACTOR TO OBTAIN COPY OF TOWER DESIGN DRAWINGS, IF AVAILABLE, FROM VERIZON PROJECT MANAGER TO CONFIRM COAX ROUTING AND ANTENNA MOUNT INFORMATION.
- 1.08 THE CONTRACTOR SHALL PROVIDE ADEQUATE EXCAVATION SLOPING, SHORING, BRACING, AND GUYS IN ACCORDANCE WITH ALL NATIONAL, STATE, AND LOCAL SAFETY ORDINANCES.
- 1.09 UPON COMPLETION OF CONSTRUCTION, CONTRACTOR IS RESPONSIBLE FOR REPAIRING ANY DAMAGE CAUSED BY CONSTRUCTION ACTIVITIES TO THE EXISTING ACCESS ROAD AND COMPOUND GRAVEL AREAS. ANY NEW FILL MATERIALS SHALL BE COMPACTED
- 1.10 THE CONTRACTOR IS HEREBY NOTIFIED THAT PRIOR TO COMMENCING CONSTRUCTION, HE IS RESPONSIBLE FOR CONTACTING THE UTILITY COMPANIES INVOLVED AND SHALL REQUEST A VERIFICATION AT THE CONSTRUCTION SITE OF THE LOCATIONS OF THEIR UNDERGROUND UTILITIES AND WHERE THEY MAY POSSIBLY CONFLICT WITH THE PLACEMENT OF IMPROVEMENTS AS SHOWN ON THESE PLANS. THE CONTRACTOR OR ANY SUBCONTRACTOR FOR THIS CONTRACT WILL BE REQUIRED. TO NOTIFY "NORTH CAROLINA 811" 48 HOURS IN ADVANCE OF PERFORMING ANY WORK BY CALLING THE TOLL FREE NUMBER (800) 632—4949 (OR 811). ANY UTILITIES DAMAGED BY CONSTRUCTION ACTIVITIES SHALL BE REPAIRED BY THE CONTRACTOR, AT NO EXPENSE TO THE OWNER.
- 1.11 CONTRACTOR TO PROVIDE DUMPSTER AND PORTABLE TOILET FACILITY DURING CONSTRUCTION.
- 1.12 CONTRACTOR TO PROVIDE STYMIE LOCK OR EQUIVALENT AS APPROVED BY VERIZON PROJECT MANAGER.
- 1.13 CONTRACTOR TO PROVIDE ANY NECESSARY SIGNAGE PER VERIZON PROJECT MANAGER'S INSTRUCTIONS. SEE DETAIL ON SHEET C11.

2.00 EQUIPMENT FOUNDATION NOTES

- 2.01 FOUNDATIONS ARE DESIGNED FOR A PRESUMPTIVE ALLOWABLE SOIL BEARING CAPACITY OF 2,000 PSF. CONTRACTOR SHALL VERIFY SOIL CONDITIONS AND BEARING CAPACITY PRIOR TO CONSTRUCTION.
- 2.02 EXCAVATE A MINIMUM 18" BELOW PROPOSED EQUIPMENT FOUNDATIONS OF EXPANSIVE, ORGANIC, UNCONSOLIDATED OR OTHERWISE UNACCEPTABLE MATERIAL AND REPLACE WITH WELL—COMPACTED MATERIAL ACCEPTABLE TO VERIZON.
- 2.03 CONTRACTOR SHALL BE RESPONSIBLE FOR LOCATING, PROTECTING, AND RELOCATING AS REQUIRED ALL SERVICE AND UTILITY LINES IN VICINITY OF THE WORK SITE. ALL EXCAVATIONS NEAR THESE LINES TO BE CARRIED OUT WITH EXTREME CAUTION. COORDINATE ALL RELOCATIONS WITH THE PROPERTY OWNER.
- 2.04 CONTRACTOR TO CUT/FILL EXISTING COMPOUND SUBSOIL TO PROVIDE AN AREA AS LEVEL AS POSSIBLE FOR THE EQUIPMENT FOUNDATIONS. ALL FILL AREAS ARE TO BE FILLED WITH SUITABLE MATERIALS. FILL MATERIALS ARE TO BE PLACED, COMPACTED, AND TESTED IN MAXIMUM LAYERS OF 8". COMPACTION OF ALL FILL MATERIAL SHALL ACHIEVE 95 PERCENT OF MAXIMUM DRY DENSITY AT OPTIMUM MOISTURE CONTENT IN ACCORDANCE WITH ASTM D 698. ALL TESTS MUST MEET THE MINIMUM SPECIFIED SOIL BEARING CAPACITY. COMPACTION TESTING IS BY THE GEOTECHNICAL TESTING COMPANY DESIGNATED FOR THE PROJECT. SCHEDULING AND COORDINATION IS THE RESPONSIBILITY OF THE GENERAL CONTRACTOR. REPORTS OF ALL TESTING ARE TO BE PROMPTLY DELIVERED OR FAXED TO THE VERIZON WIRELESS PROJECT MANAGER.
- 2.05 CONCRETE SHALL HAVE A MINIMUM COMPRESSIVE STRENGTH OF 4,000 PSI AT 28 DAYS AND SHALL BE INSTALLED IN ACCORDANCE WITH THE LATEST REVISION TO ACI-318 BUILDING CODE REQUIREMENTS FOR REINFORCED CONCRETE.
- 2.06 CONCRETE SHALL HAVE A SLUMP BETWEEN 3" AND 6".
- 2.07 FIBERS FOR CONCRETE SHALL BE FIBERMESH 650, 100 PERCENT VIRGIN POLYPROPYLENE FIBRILLATED FIBERS, e3 PATENTED TECHNOLOGY PATENTED TECHNOLOGY, CONTAINING NO REPROCESSED OLEFIN MATERIALS. THE FIBERS SHALL CONFORM TO ASTM C1116 TYPE III AND MANUFACTURED SPECIFICALLY FOR THE SECONDARY REINFORCEMENT OF CONCRETE.
- 2.08 THE FIBERS SHALL BE MANUFACTURED IN AN ISO 9001: 2008 CERTIFIED MANUFACTURING FACILITY. UNLESS OTHERWISE STATED, FIBERMESH 650 MACRO—SYNTHETIC FIBERS SHALL BE ADDED TO THE CONCRETE AT THE BATCHING PLANT AT THE RECOMMENDED APPLICATION RATE OF 3 LBS/YD³ AND MIXED FOR A SUFFICIENT TIME (MINIMUM 5 MINUTES AT FULL MIXING SPEED) TO ENSURE UNIFORM DISTRIBUTION OF THE FIBERS THROUGHOUT THE CONCRETE. FIBROUS CONCRETE REINFORCEMENT SHALL BE MANUFACTURED BY FIBERMESH, 4019 INDUSTRY DRIVE, CHATTANOOGA, TN 37416 USA, TEL: 800 621—1273, WEBSITE: WWW.FIBERMESH.COM
- 2.09 AT THE REQUEST OF THE VERIZON WIRELESS PROJECT MANAGER, TEST CYLINDERS SHALL BE MOLDED AND LABORATORY CURED IN ACCORDANCE WITH ASTM C31. THREE CYLINDERS SHALL BE TAKEN FOR EACH DAY'S CONCRETE PLACEMENT. CYLINDERS SHALL BE TESTED IN ACCORDANCE WITH THE LATEST REVISION TO ASTM C39.
- 2.10 CHAMFER ALL EXPOSED EXTERNAL CORNERS OF CONCRETE WITH $\frac{3}{4}$ " x 45° CHAMFER, UNLESS OTHERWISE NOTED.
- 2.11 CONCRETE FORMWORK IS TO BE STRIPPED WITHIN 48 HOURS. VIBRATION OF THE CONCRETE MUST ASSURE THAT HONEYCOMBING WILL BE AT A MINIMUM. MECHANICAL VIBRATION OF ALL CONCRETE IS REQUIRED UNLESS OTHERWISE DIRECTED BY VERIZON WIRELESS' PROJECT MANAGER. ABOVE GRADE CONCRETE IS TO BE RUBBED AND PATCHED TO ASSURE SMOOTH FINISH AT TIME OF FORMS REMOVAL. CONTRACTOR SHALL PROVIDE A BROOM FINISH ON THE TOP SURFACE OF THE EQUIPMENT FOUNDATION UNLESS OTHERWISE DIRECTED BY VERIZON WIRELESS' PROJECT MANAGER.
- 2.12 TOPS OF CONCRETE FOUNDATION MUST BE WITHIN 0.02' OF ELEVATION REQUIRED.
- 2.13 TOP OF FOUNDATION FINISH TO BE LEVEL $\pm \frac{1}{8}$ " IN 10'.
- 2.14 TOP OF FOUNDATION TO HAVE MEDIUM BROOM FINISH.
- 2.15 CONTRACTOR SHALL REFER TO DRAWINGS OF OTHER TRADES AND VENDOR DRAWINGS FOR EMBEDDED ITEMS AND RECESSES NOT SHOWN ON THE STRUCTURAL DRAWINGS. CONTRACTOR SHALL VERIFY PLACEMENT OF EQUIPMENT AND LOCATION OF CONDUIT FOR MANUFACTURER'S AND VENDORS SPECIFICATIONS. IT SHALL BE THE RESPONSIBILITY OF THE CONTRACTOR TO PROVIDE ALL OPENINGS AND SLEEVES FOR PROPER DISTRIBUTION OF ALL UTILITIES

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8921 RESEARCH DRIVE CHARLOTTE, NORTH CAROLINA 2826


PROJECT INFORMATION:

SITE NAME: LUTTERLOH SITE No.: 431701 PROJECT #: 20192010936 0 NC 87 N PITTSBORO, NC 27312 CHATHAM COUNTY

PLANS PREPARED BY:

Kimley » Horn

11720 AMBER PARK DRIVE, SUITE 600 ALPHARETTA, GA 30009 PHONE: 770-619-4280 WWW.KIMLEY-HORN.COM NC License F-0102

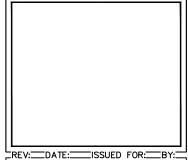

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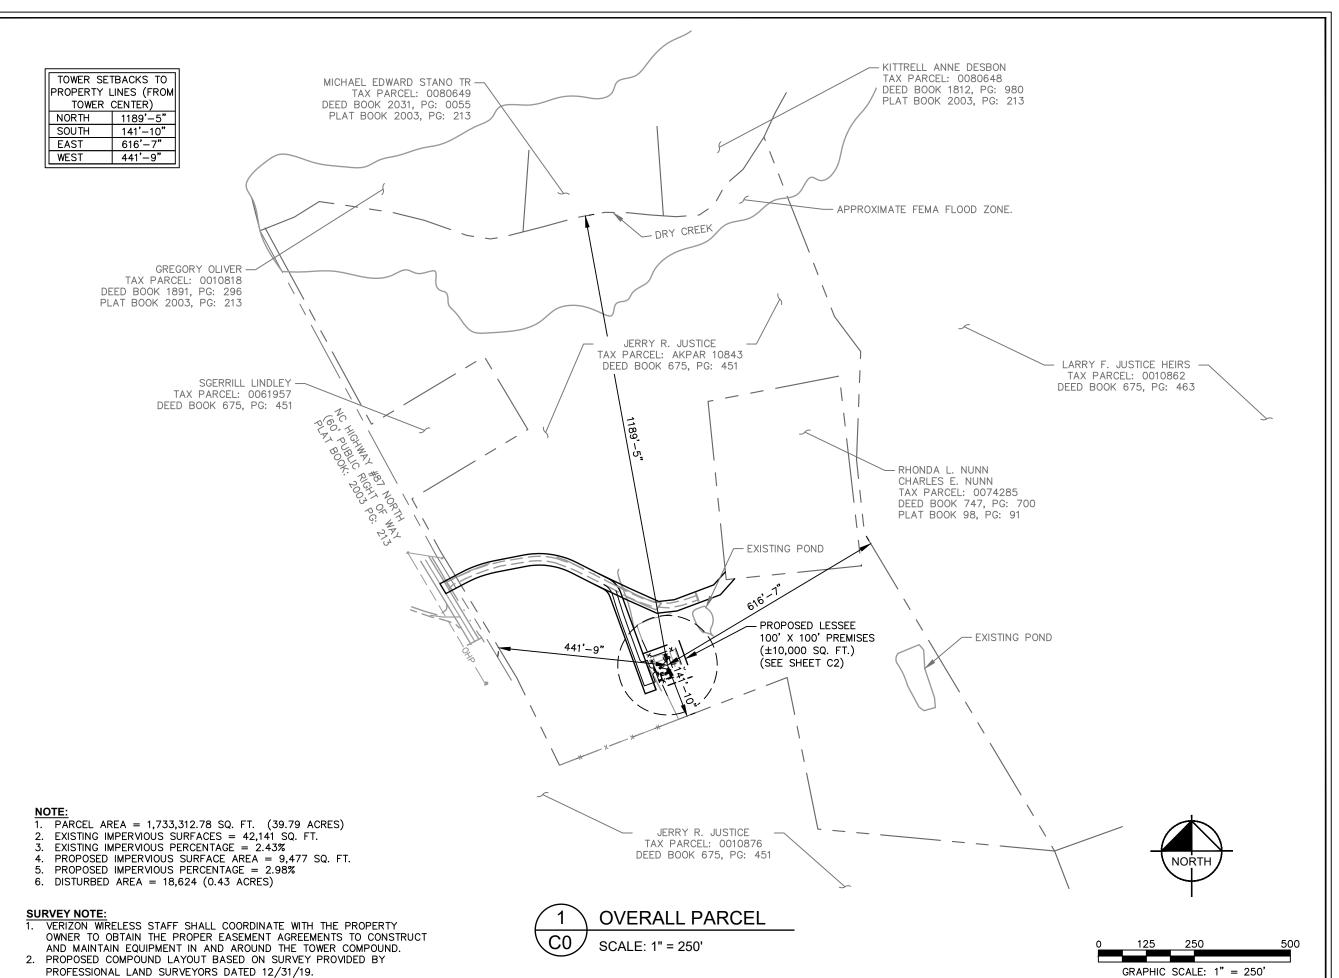
GENERAL NOTES

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SITE NAME: LUTTERLOH SITE No.: 431701 PROJECT #: 20192010936 0 NC 87 N PITTSBORO, NC 27312 CHATHAM COUNTY

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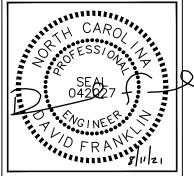
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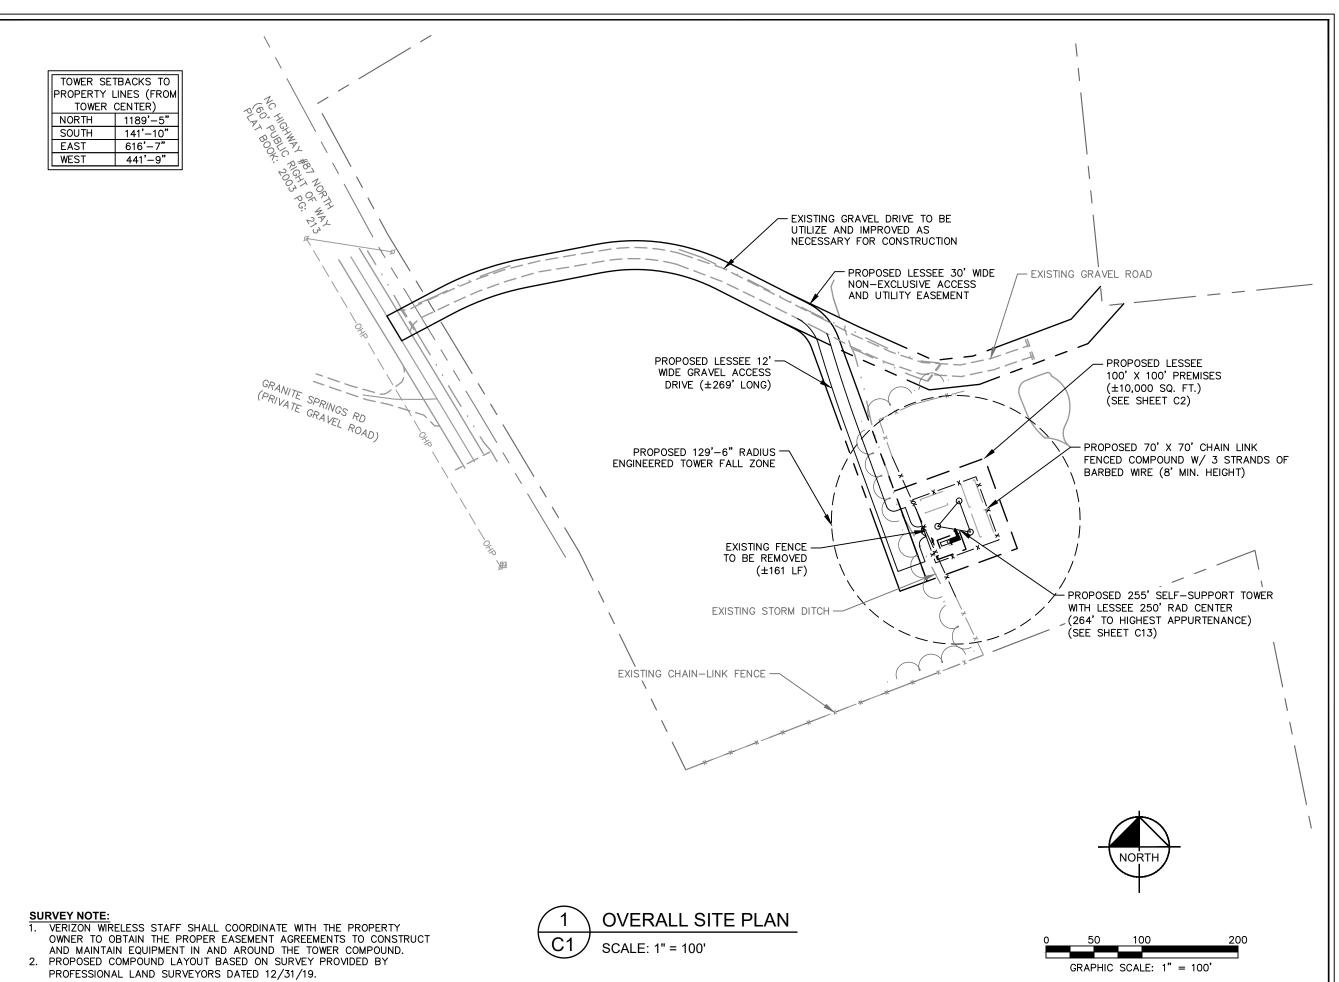
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PROJECT INFORMATION:

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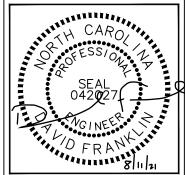
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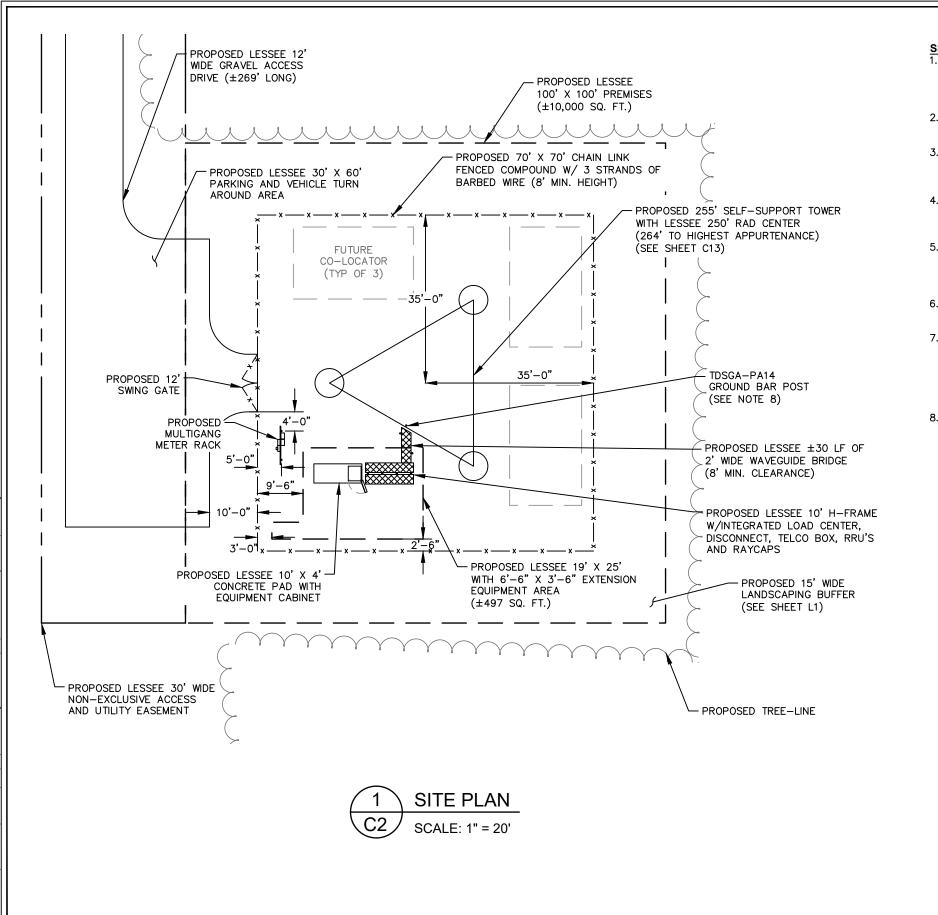
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OVERALL SITE PLAN

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SITE NOTES:

- 1. VERIZON WIRELESS STAFF SHALL COORDINATE WITH THE PROPERTY OWNER AND/OR TOWER OWNER TO OBTAIN THE PROPER EASEMENT AGREEMENTS TO CONSTRUCT AND MAINTAIN EQUIPMENT IN AND AROUND THE TOWER COMPOUND.
- 2. PROPOSED COMPOUND LAYOUT BASED ON SURVEY PROVIDED BY PROFESSIONAL LAND SURVEYORS DATED 12/31/19.
- 3. CONTRACTOR TO CONFIRM WITH VERIZON CONSTRUCTION MANAGER THAT THE SHELTER/EQUIPMENT SHOWN HAS BEEN ORDERED/SCHEDULED FOR DELIVERY TO THIS SITE.
- 4. THE BASIS OF EQUIPMENT DESIGN INCLUDES ONE (1) RF CABINET, ONE (1) FUTURE BATTERY CABINET, AND ONE (1) FUTURE EXPANSION
- 5. GENERAL CONTRACTOR SHALL BE RESPONSIBLE FOR COORDINATING AND MODIFYING SCOPE OF WORK TO ACCOMMODATE ANY CHANGES IN THE EXACT EQUIPMENT PROCURED BY VERIZON WIRELESS. COORDINATE ANY CHANGES WITH VERIZON WIRELESS CONSTRUCTION MANAGER.
- 6. ROUTE COAX/FIBER UP TOWER PER STRUCTURAL ANALYSIS BY TOWER
- 7. TOWER DIMENSIONS SHOWN ON THIS PLAN ARE FOR TOWER CENTER LOCATION. CONTRACTOR TO OBTAIN COPY OF TOWER ERECTION DRAWINGS FROM VERIZON CONSTRUCTION MANAGER PRIOR TO DRILLING TOWER FOUNDATIONS. CASSIONS AND TOWER SHOWN ON THIS PLAN ARE ILLUSTRATIVE, SEE DESIGN DRAWING BY OTHERS. DO NOT
- 8. INSTALL 3½" O.D. GALVANIZED STEEL POST FOR TDSGA-PA14 GROUND BAR. POST TO EXTEND 78" ABOVE GRADE AND SHALL BE EMBEDDED IN A 12" OCONCRETE FOOTING A MINIMUM OF 36". FOOTING SHALL EXTEND A MINIMUM OF 42" BELOW GRADE.



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PROJECT INFORMATION:

SITE NAME: LUTTERLOH SITE No.: 431701 PROJECT #: 20192010936 0 NC 87 N PITTSBORO, NC 27312 CHATHAM COUNTY


TPLANS PREPARED BY: T



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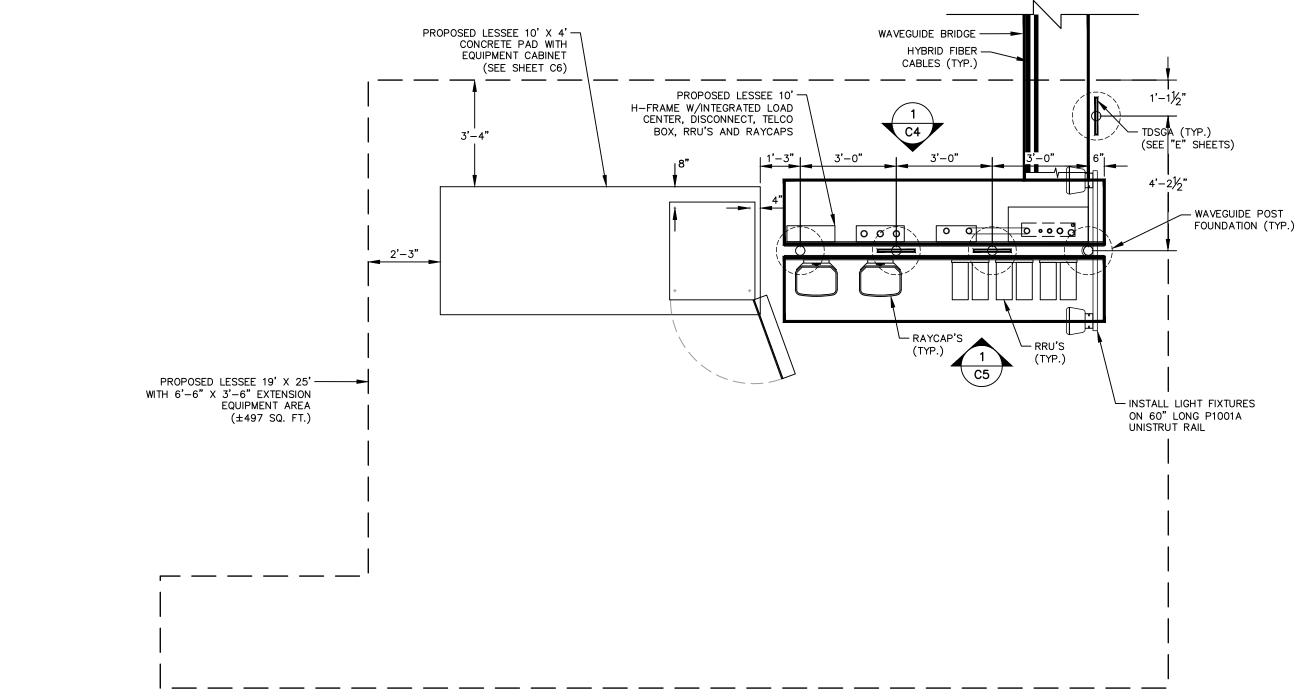
KHA PROJECT NUMBER: 013509278 CHECKED BY: DRAWN BY:

SHEET TITLE:

SITE PLAN

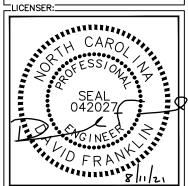SHEET NUMBER:

GRAPHIC SCALE: 1" = 20'



EQUIPMENT PAD/ROUTING NOTES:


- 1. REFER TO THE SITE PLAN FOR EQUIPMENT PAD LOCATION AND ORIENTATION.
- 2. RUN 2" FLEX TELCO CONDUIT FROM BOTTOM OF TELCO BOX TO SIDE OF RF CABINET WITH CHASE NIPPLE THROUGH FACTORY KNOCKOUT.
- 3. RUN (2) 2" FLEX POWER CONDUIT AND (1) 1" ALARM CONDUIT FROM BOTTOM OF ILC TO SIDE OF RF CABINET WITH CHASE NIPPLES THROUGH FACTORY KNOCKOUTS.
- 4. RUN 2" FLEX FIBER CONDUIT FROM BOTTOM OF OVP TO SIDE OF RF CABINET WITH CHASE NIPPLE THROUGH FACTORY KNOCKOUT.
- 5. RUN (1) 1½" FLEX POWER CONDUIT FOR EVERY (6) RRU CIRCUITS FROM BOTTOM OF OVP TO SIDE OF RF CABINET WITH CHASE NIPPLE THROUGH FACTORY KNOCKOUT.
- 6. SUPPORT FLEX CONDUIT ON HORIZONTAL H-FRAME RAILS OR ON VERTICAL SITE STRUT SNT10 RAILS ADDED TO H-FRAME FOR CONDUIT/CABLE MANAGEMENT.

EQUIPMENT PAD LAYOUT

SCALE: 1" = 3'

- 7. RUN HYBRID CABLE FOR TOWER MOUNTED RRU'S OVERHEAD ON TRAPEZE SUSPENDED FROM WAVE GUIDE BRIDGE. SWEEP DOWN ONTO H-FRAME RAILS, THEN LOOP UNDER OVP AND CONNECT TO BOTTOM OF OVP. ATTACH GROUND KITS TO HYBRID CABLE BEFORE LOOPING UNDER OVP, AND BOND TO TDSGA GROUND BAR AT BASE OF H-FRAME.
- 8. RUN COAX CABLE FOR GROUND MOUNTED RRU'S (IF USED) OVERHEAD ON TRAPEZE SUSPENDED FROM WAVE GUIDE BRIDGE. TERMINATÈ COAX ON ICE BRIDGE AND TRANSITION TO JUMPERS JUST BEFORE REACHING H-FRAME. ATTACH GROUND KITS TO COAX CABLE ON TOWER SIDE OF LAST ICE BRIDGE POST AND BOND TO TDSGA GROUND BAR NEAR TOP OF POST.
- 9. GPS ANTENNA TO BE MOUNTED TO STANDARD HEIGHT POST WITH EXTENDED MOUNTING PIPE, USING COMMSCOPE GPS-U MOUNTING KIT. MOUNT AS NEAR AS PRACTICAL TO RBA84
- 10. BOLT CABINETS AND GENERATOR TO SLAB USING FASTENERS SPECIFIED BY EQUIPMENT MANUFACTURER IN FACTORY PROVIDED MOUNTING HOLES.



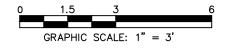



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PROJECT INFORMATION:


SITE NAME: LUTTERLOH SITE No.: 431701 PROJECT #: 20192010936 0 NC 87 N PITTSBORO, NC 27312 CHATHAM COUNTY

TPLANS PREPARED BY:

11720 AMBER PARK DRIVE SUITE 600 ALPHARETTA, GA 30009 PHONE: 770-619-4280 WWW.KIMLEY-HORN.COM NC License F-0102



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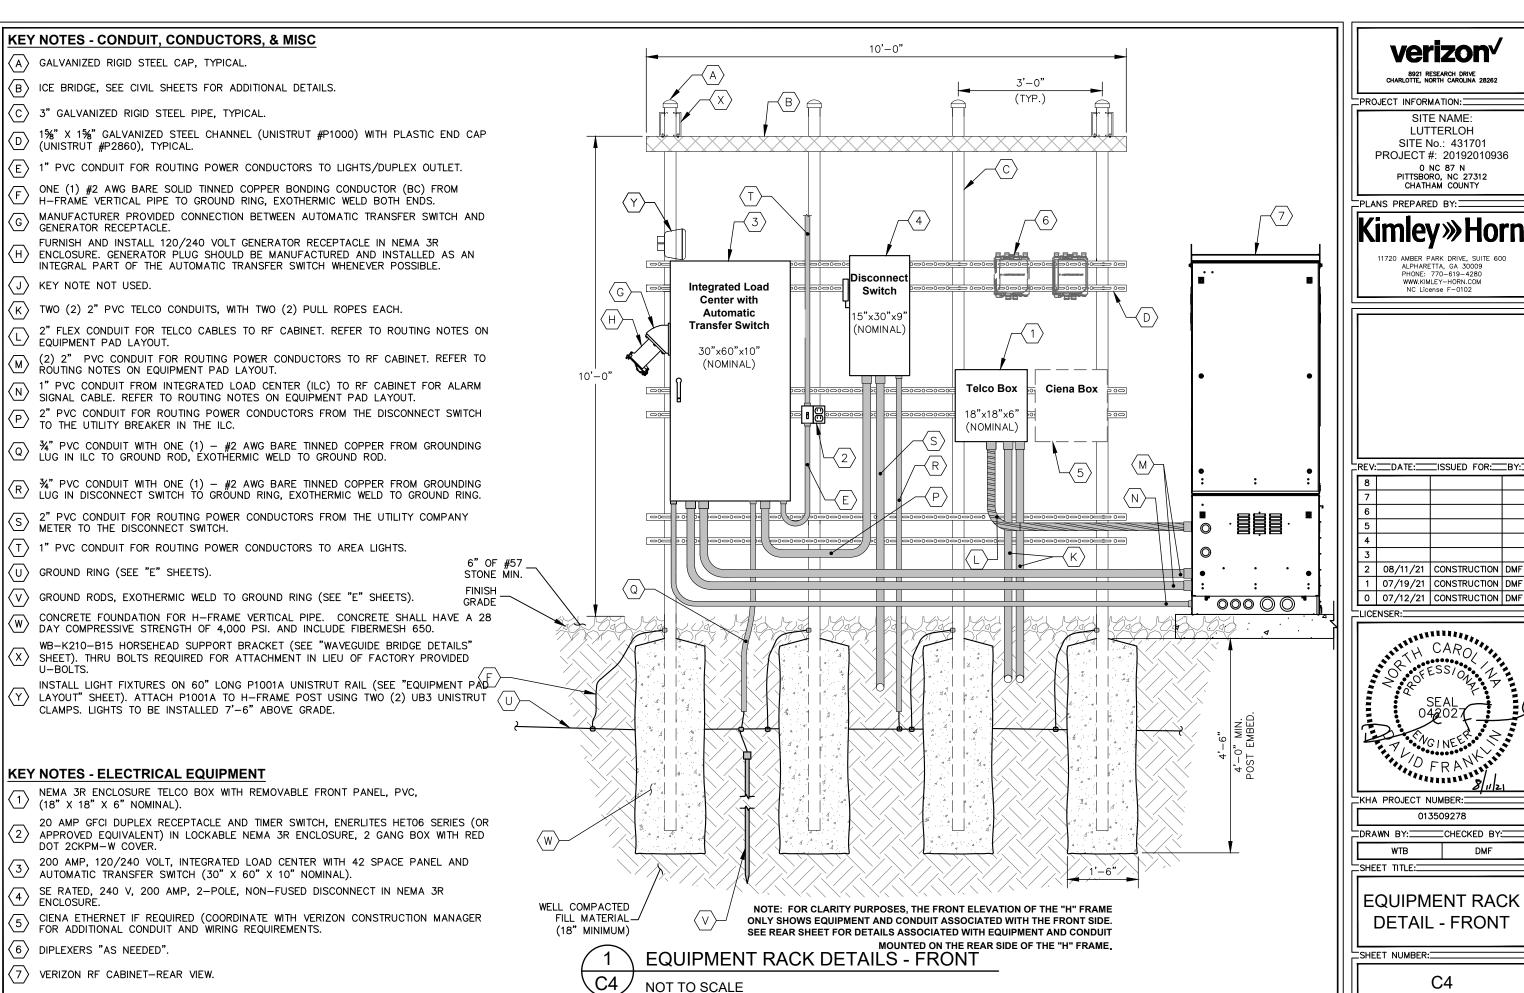
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EQUIPMENT PAD LAYOUT
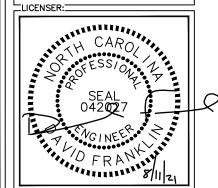
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SITE NAME: LUTTERLOH SITE No.: 431701


PROJECT #: 20192010936 0 NC 87 N PITTSBORO, NC 27312 CHATHAM COUNTY

PLANS PREPARED BY:

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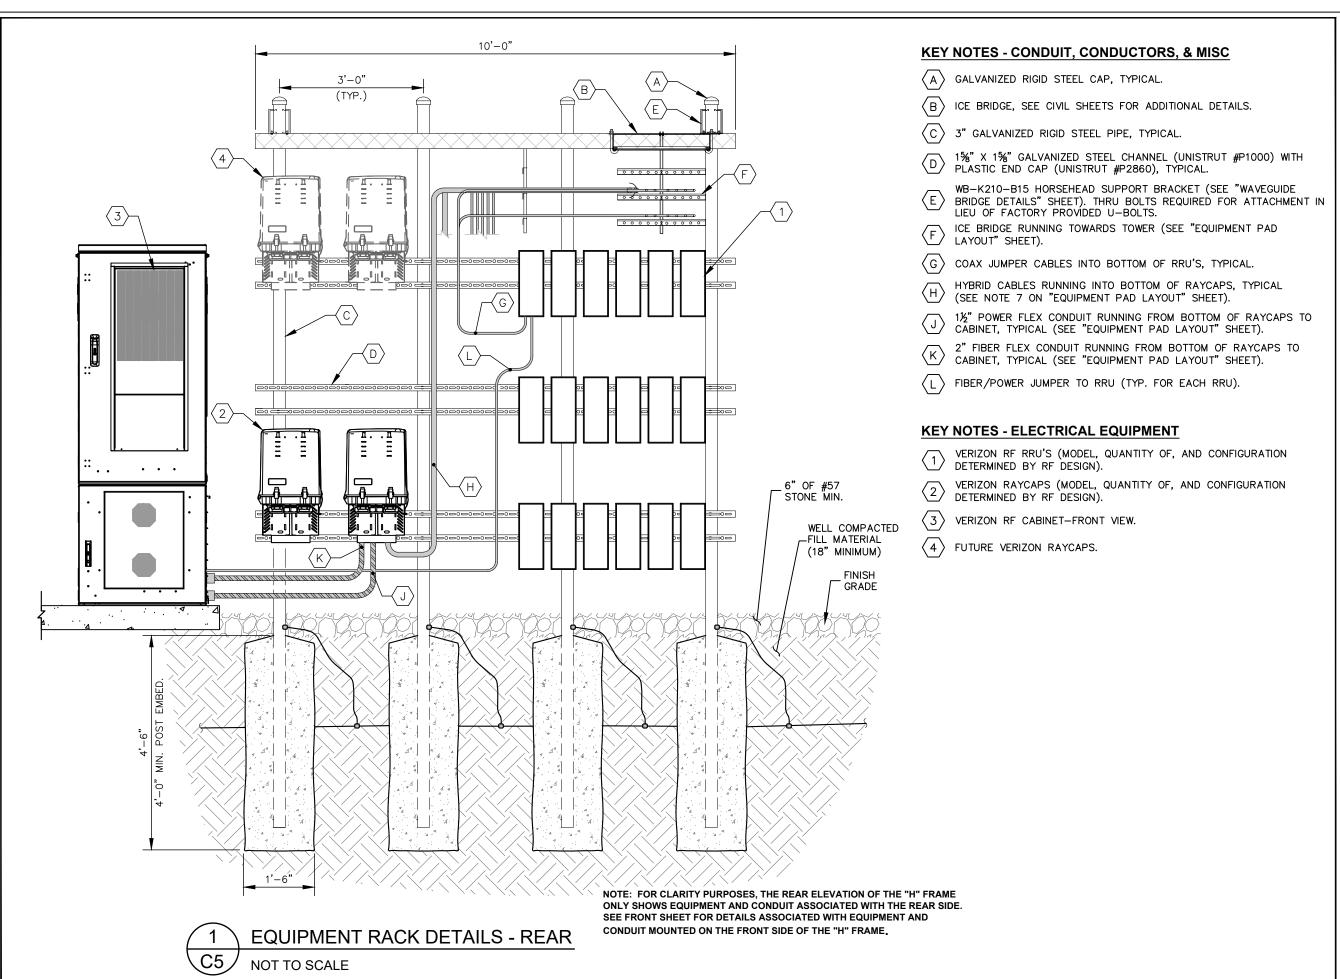
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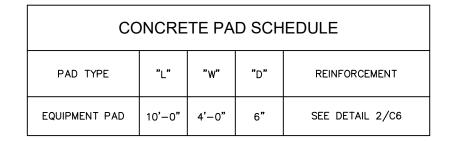
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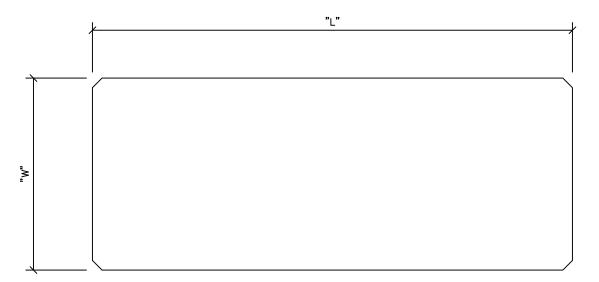
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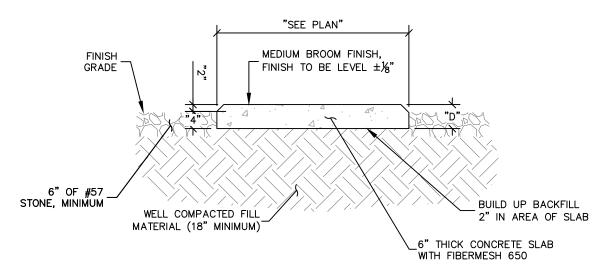
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CONCRETE PAD FOUNDATION SECTION NOT TO SCALE

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PROJECT INFORMATION:

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PLANS PREPARED BY:

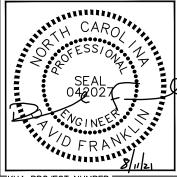


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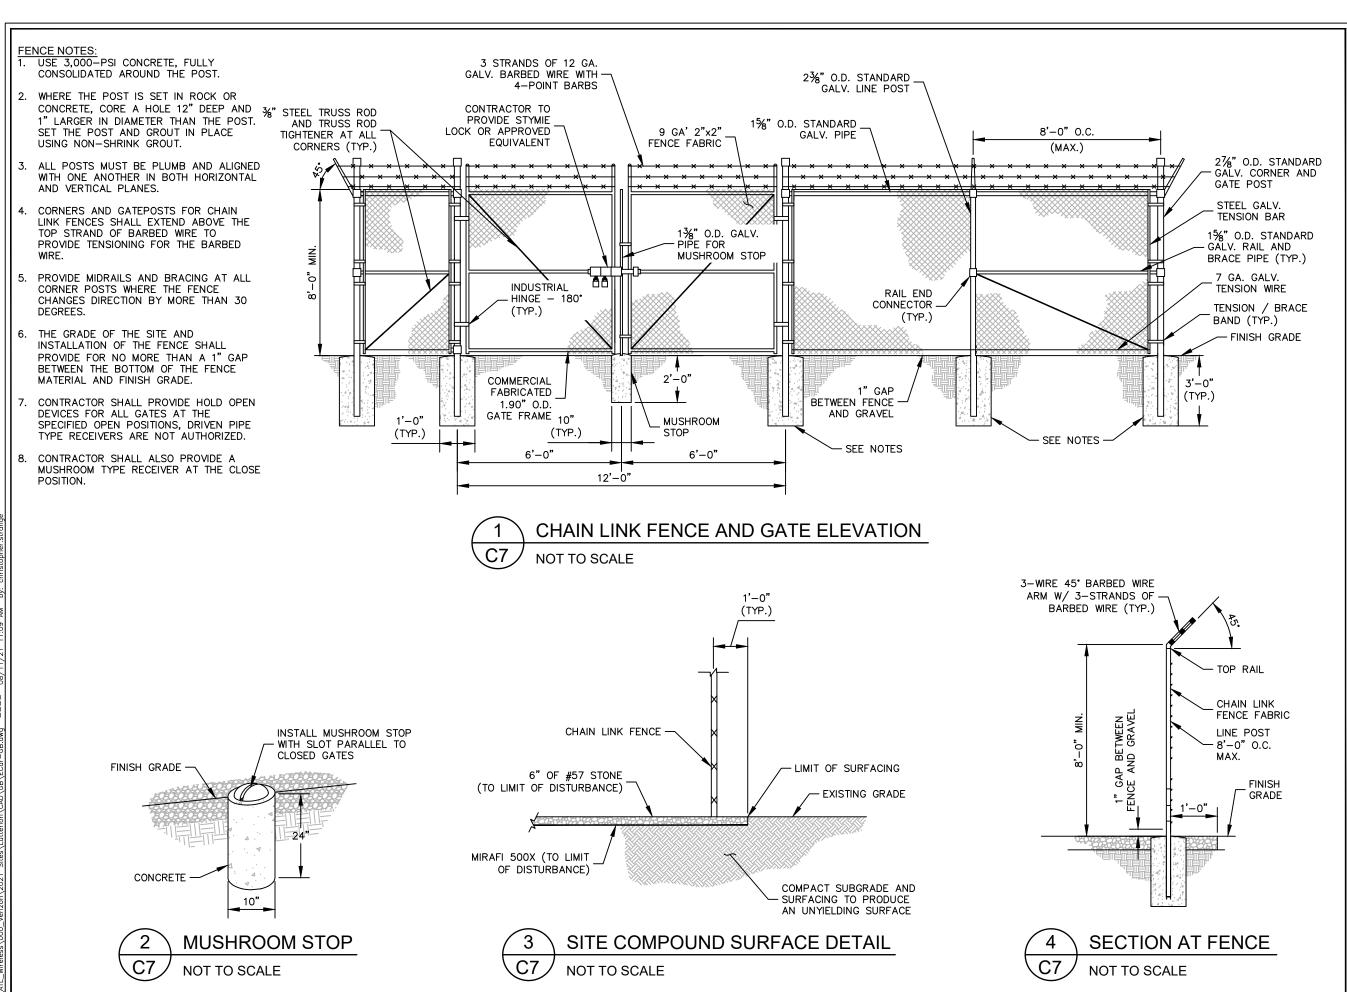
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CONCRETE PAD FOUNDATION DETAILS

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PROJECT INFORMATION:

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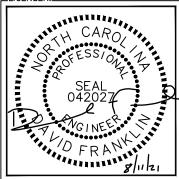
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FENCE, GATE, AND COMPOUND DETAILS

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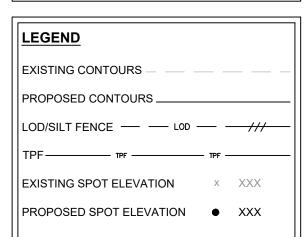
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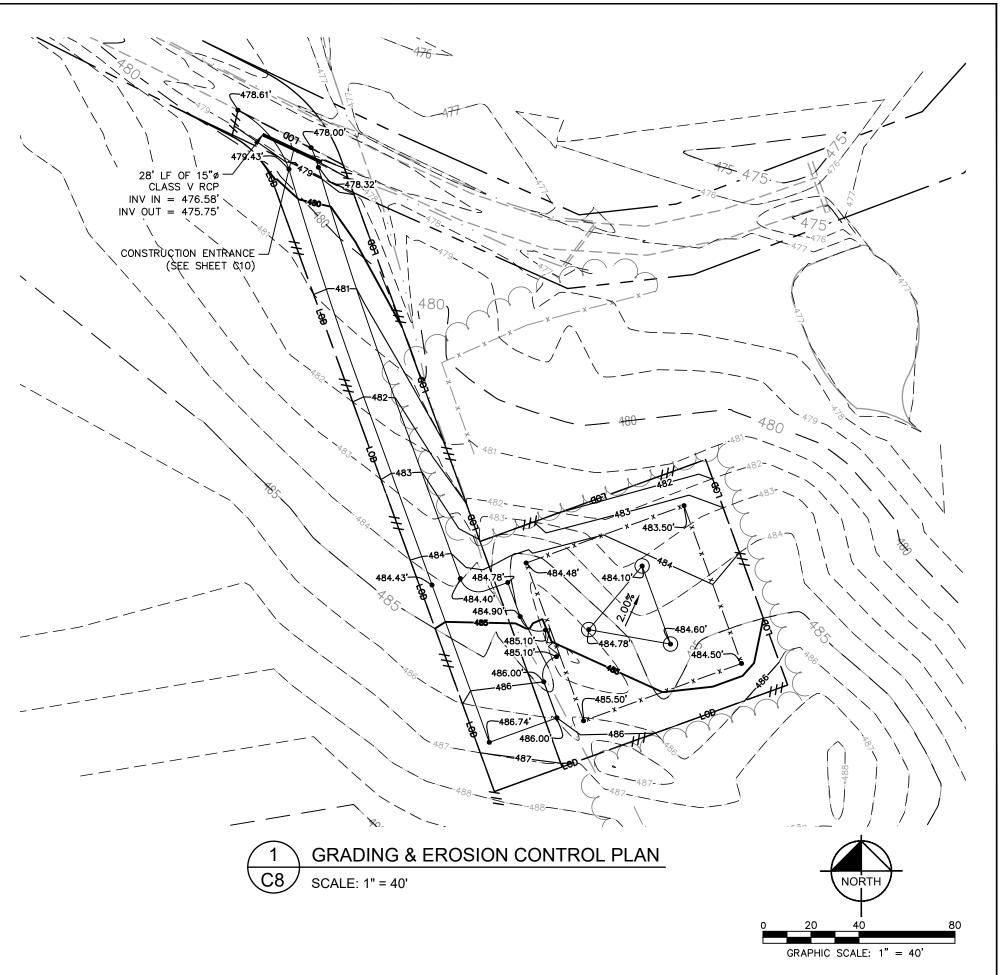
CONSTRUCTION.

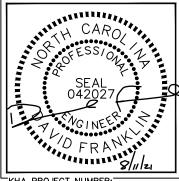- GRADING NOTES:

 1. THE CONTRACTOR SHALL CLEAR AND GRUB
 THE SITE AND PLACE, COMPACT, AND

 CONTRACT ALL FILL PER THE MOISTURE CONDITION ALL FILL PER THE PROJECT GEOTECHNICAL ENGINEERS SPECIFICATIONS. FILL MATERIAL SHALL BE APPROVED BY THE GEOTECHNICAL ENGINEER PRIOR TO PLACEMENT.
- ALL PROPOSED CONTOURS AND SPOT ELEVATIONS REFLECT FINISHED GRADES.
- 3. CONTRACTOR SHALL BLEND EARTHWORK SMOOTHLY TO TRANSITION BACK TO EXISTING GRADE.
- PORTIONS OF THE SITE NOT SPECIFICALLY MENTIONED WITHIN THE GEOTECHNICAL REPORT SHALL BE COMPACTED TO 95 PERCENT OF THE MATERIALS MAXIMUM DRY DENSITY WITHIN 3 PERCENT OF OPTIMUM MOISTURE CONTENT.
- 5. FILL SHALL BE PLACED IN MAXIMUM 8 INCH LOOSE LIFTS.
- 6. UNDISTURBED AREAS WITHIN 30' INGRESS/EGRESS EASEMENT NOT NEEDED FOR UTILITY ROUTING TO BE LEFT UNDISTURBED.
- GROUND WATER SHOULD BE REASONABLY EXPECTED. ANY DE-WATERING OR MOISTURE CONDITIONING IS THE RESPONSIBILITY OF THE CONTRACTOR AND SHOULD BE INCLUDED IN THE CONTRACT
- SEED ALL DISTURBED AREAS NOT TOPPED WITH GRAVEL PER SEEDING SCHEDULE ON DETAIL ON SHEET C9.
- MAXIMUM CUT SLOPE = 2H:1V UNLESS OTHERWISE NOTED.
- 10. MAXIMUM FILL SLOPE = 3H:1V UNLESS OTHERWISE NOTED.





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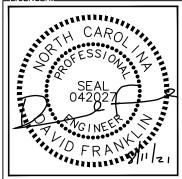
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TKHA PROJECT NUMBER:

013509278 DRAWN BY: CHECKED BY:

SHEET TITLE:

GRADING AND EROSION CONTROL PLAN

SHEET NUMBER:

EROSION CONTROL NOTES:

- 1. EROSION CONTROLS SHALL BE INSTALLED PRIOR TO CONSTRUCTION AND SHALL BE ADEQUATE TO MAINTAIN SEDIMENT ON
- 2. ALL EXCAVATED SOILS NOT NEEDED ON SITE FOR BACKFILL OPERATIONS SHALL BECOME PROPERTY OF THE CONTRACTOR AND SHALL BE TAKEN OFF SITE AND LEGALLY DISPOSED OF.
- 3. SOIL REMAINING ON SITE SHALL HAVE SILT FENCE TIGHTLY PLACED AROUND THE ENTIRE CIRCUMFERENCE OF THE PILE.
- 4. PROVIDE EROSION CONTROLS AS NECESSARY TO PREVENT EXISTING SOILS FROM DRAINING OFF SITE OR INTO EXISTING DRAINAGE STRUCTURES.
- 5. ERECTION OF EROSION CONTROLS SHALL BE IN ACCORDANCE WITH STATE AND LOCAL EROSION CONTROL REGULATIONS.

SEEDING SCHEDULE FOR WINTER / SPRING CONSTRUCTION ACTIVITIES

SEEDING MIXTURE

Rate (lb/acre) Species Rye (grain) 120 Annual lespedeza (Kobe in Piedmont and Coastal Plain, Korean in Mountains)

Omit annual lespedeza when duration of temporary cover is not to extend beyond June.

SEEDING DATES

Mountains-- Above 2500 ft: Feb 15 - May 15 Below 2500 ft.: feb. 1 - May 1 Piedmont--Jan. 1 - May 1 Coastal Plain--Dec. 1 - Apr. 15

SOIL AMENDMENTS

Follow recommendations of soil tests or apply 2,000 lb/acre ground agricultural limestone and 750 lb/acre 10-10-10 fertilizer.

MULCH

Apply 4,000 lb/acre straw. Anchor straw by tacking with asphalt, netting, or a mulch anchoring tool. A disk with blades set nearly straight can be used as a mulch anchoring tool.

MAINTENANCE

Refertilize if growth is not fully adequate. Reseed, refertilize and mulch immediately following erosion or other damage.

SEEDING SCHEDULE FOR SUMMER CONSTRUCTION ACTIVITIES

SEEDING MIXTURE

Rate (lb/acre) Species Common Bermudagrass 40-80 (1-2 lb/1,000 sq.

SEEDING DATES


Coastal Plain——Apr. 1 — July Piedmont——Apr. 15 — June 30

SOIL AMENDMENTS

Apply lime and fertilizer according to soil tests, or apply 3,000 lb/acre ground agricultural limestone and 500 lb/acre 10-10-10 fertilizer.


Use jute, excelsior matting, or other effective channel lining material to cover the bottom of channels and ditches. The lining should extend above the highest calculated depth of flow. On channel side slopes above this height, and in drainages not requiring temporary lining, apply 4,000 lb/acre grain straw and anchor straw by stapling netting over the top.

A minimum of 3 weeks is required for establishment. Inspect and repair mulch frequently. Refertilize the following Apr. with 50 lb/acre nitrogen.

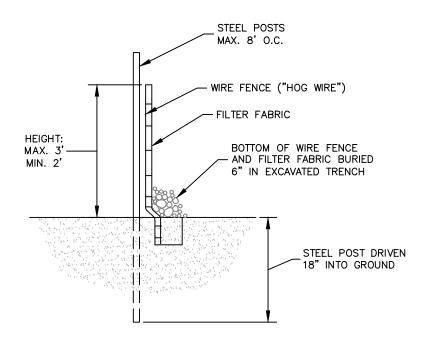

SECTION

SEDIMENT FENCE (SILT FENCE) NOT TO SCALE

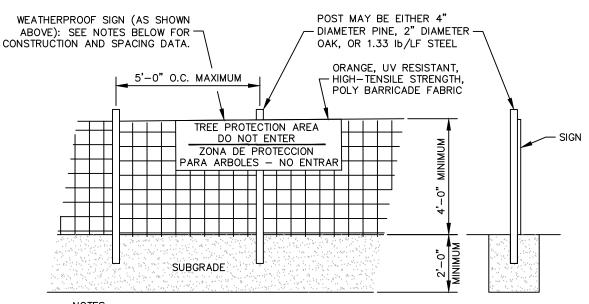

INSTALL TREE PROTECTION FENCE AND SIGNAGE PRIOR TO CALLING FOR SITE INSPECTION. MAINTAIN TREE PROTECTION FENCE THROUGHOUT DURATION OF PROJECT. ADDITIONAL SIGNS MAY BE REQUIRED BASED ON ACTUAL FIELD CONDITIONS.





PROJECT INFORMATION:

SITE NAME: LUTTERLOH SITE No.: 431701 PROJECT #: 20192010936 0 NC 87 N PITTSBORO, NC 27312

CHATHAM COUNTY

TPLANS PREPARED BY: T




11720 AMBER PARK DRIVE SUITE 600 ALPHARETTA, GA 30009 PHONE: 770-619-4280 WWW.KIMLEY-HORN.COM NC License F-0102

REV: DATE: ISSUED FOR: BY:

2 08/11/21 CONSTRUCTION DMF 1 07/19/21 CONSTRUCTION DMF 0 07/12/21 CONSTRUCTION DMF

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KHA PROJECT NUMBER:

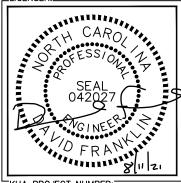013509278 CHECKED BY:

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SHEET TITLE:


GRADING AND EROSION CONTROL DETAILS

SHEET NUMBER:


- NOTES:

 1. PUT SILT FENCE OR TREE PROTECTION FENCE UP TO ENSURE CONSTRUCTION ENTRANCE IS USED.

 1. CONSTRUCTION ON THE SITES ARE SUCH THAT THE MUD IS
- IF CONSTRUCTION ON THE SITES ARE SUCH THAT THE MUD IS NOT REMOVED BY THE VEHICLE TRAVELING OVER THE STONE, THEN THE TIRES OF THE VEHICLES MUST BE WASHED BEFORE ENTERING THE PUBLIC ROAD.
- IF A PROJECT CONTINUES TO PULL MUD AND DEBRIS ON TO THE PUBLIC ROAD, THE GOVERNING AUTHORITY WILL CLEAN THE AREA AND INVOICE THE FINANCIALLY RESPONSIBLE PERSON AS INDICATED ON THE FINANCIAL RESPONSIBILITY

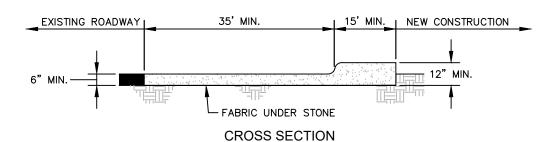



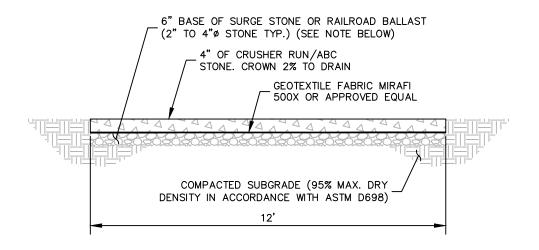

IF DETERMINED NECESSARY DURING GRADING AND CONSTRUCTION OF THE ACCESS ROAD BY THE VERIZON WIRELESS PROJECT MANAGER, THE CONTRACTOR SHALL INSTALL 6" BASE OF SURGE STONE OR RAILROAD BALLAST (2" TO 4" STONE TYP.)

STANDARD ACCESS ROAD AND TURN-AROUND DETAIL

NOT TO SCALE

verizon^v

8921 RESEARCH DRIVE CHARLOTTE, NORTH CAROLINA 28262

SITE NAME: LUTTERLOH SITE No.: 431701

PROJECT #: 20192010936 0 NC 87 N PITTSBORO, NC 27312 CHATHAM COUNTY

TPLANS PREPARED BY: T


PROJECT INFORMATION:

11720 AMBER PARK DRIVE, SUITE 600 ALPHARETTA, GA 30009 PHONE: 770-619-4280 WWW.KIMLEY-HORN.COM NC License F-0102



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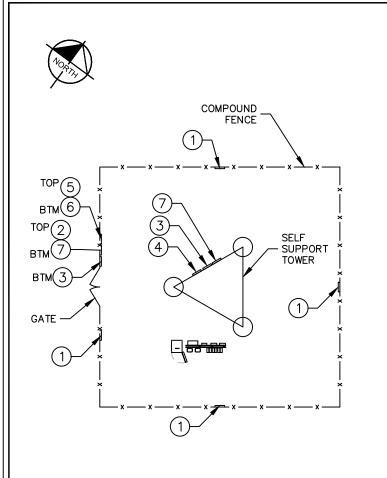
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LDRAWN BY: CHECKED BY:

SHEET TITLE:

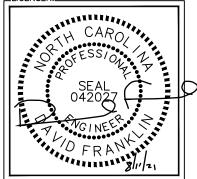ACCESS ROAD DETAILS

SHEET NUMBER:



SIGN PLACEMENT PLAN VIEW

C11

NOT TO SCALE



18" HIGH X 24" WIDE

(OPERATIONS PROVIDED)

WHITE BACKGROUND W/
RED LETTERING

This is a Verizon Wireless
Antenna Site

Site ID:
For information call:

800-264-6620

WHITE BACKGROUND W/
BLACK LETTERING

WHITE BACKGROUND W/
BLACK LETTERING

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BLACK LETTERING

All personnel should have electromagnetic energy (EME) awareness training.
All personnel entering this site must be authorized.

Cley all posted signs,
Assume all antennas are active.
Bedrow working on antennas, northy owners and disable appropriate transmittes.

Maintain minimum 3 feet clearance from all antennas.
Do not stop in front of antennas.
Newer operate transmitters without shelds during normal operation.
Do not operate base station antennas in equipment room.


BLUE BACKGROUND w/

② VERIZON WIRELESS - SITE ID SIGN

YELLOW BACKGROUND w/


15" HIGH X 23" WIDE (OPERATIONS PROVIDED) 3 NOTICE-RFE SIGN

12" HIGH X 18" WIDE (OPERATIONS PROVIDED)

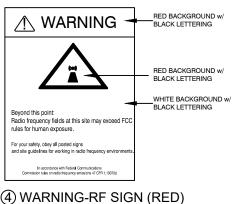



∴ CAUTION

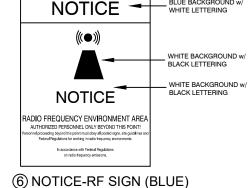

(5) CAUTION-RF SIGN (YELLOW)
12" WIDE X 18" HIGH

12" WIDE X 18" HIGH

FCC TOWER REGISTRATION NO.

WHITE W/BLACK LETTERING

7 FCC REGISTRATION SIGN


20 WIDE X 4" HIGH

12" WIDE X 18" HIGH

2

TYPICAL SIGNS AND SPECIFICATIONS

NOT TO SCALE

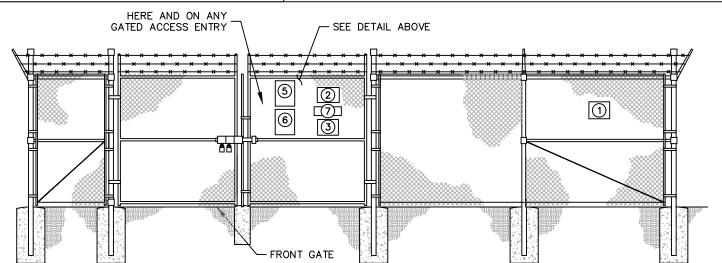

SIGN PLACEMENT FRONT GATE VIEW

NOT TO SCALE

SIGNAGE NOTES:

- 1. SIGNS SHALL BE FABRICATED FROM CORROSION RESISTANT PRESSED METAL, AND PAINTED WITH LONG LASTING UV RESISTANT COATINGS.
- 2. SIGNS (EXCEPT WHERE NOTED OTHERWISE) SHALL BE MOUNTED TO THE TOWER, GATE, AND FENCE USING A MINIMUM OF 9 GAUGE ALUMINUM WIRE, HOG RINGS (AS UTILIZED IN FENCE INSTALLATIONS) OR BRACKETS WHERE NECESSARY. BRACKETS SHALL BE OF SIMILAR METAL AS THE STRUCTURE TO AVOID GALVANIC CORROSION.

verizon/

8921 RESEARCH DRIVE CHARLOTTE, NORTH CAROLINA 282

PROJECT INFORMATION:

SITE NAME: LUTTERLOH SITE No.: 431701 PROJECT #: 20192010936 0 NC 87 N PITTSBORO, NC 27312 CHATHAM COUNTY


TPLANS PREPARED BY:

Kimley Horr

11720 AMBER PARK DRIVE, SUITE 600 ALPHARETTA, GA 30009 PHONE: 770-619-4280 WWW.KIMLEY-HORN.COM NC License F-0102



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SITE SIGNAGE

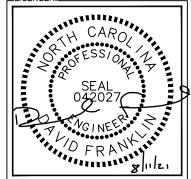
DETAILS

SHEET NUMBER:


C1'

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NOT TO SCALE

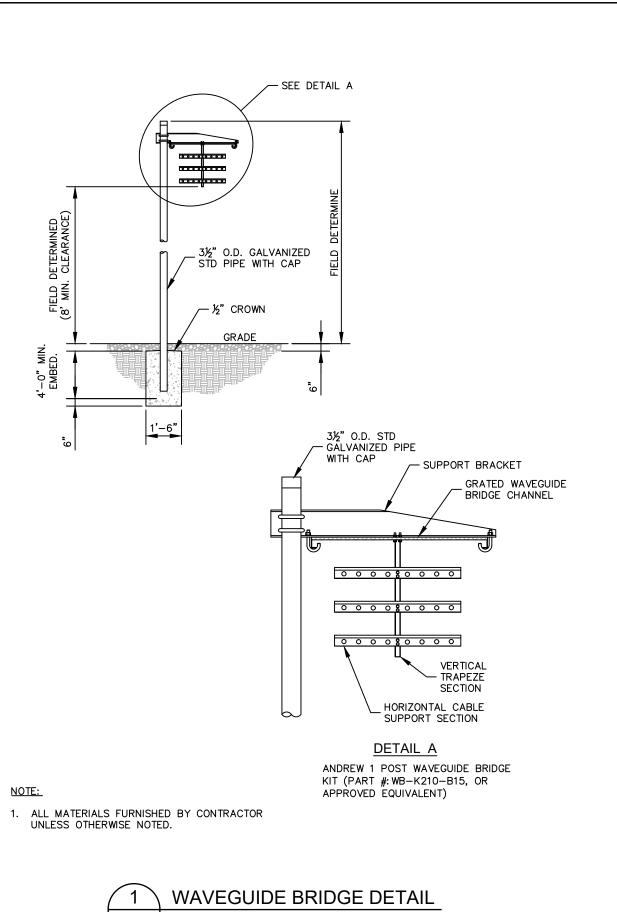

NOTE:

1. ALL MATERIALS FURNISHED BY CONTRACTOR UNLESS OTHERWISE NOTED.

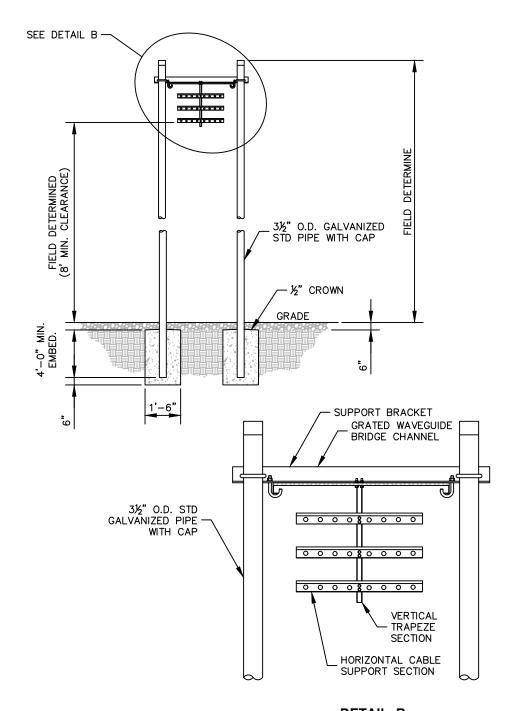DETAIL B

ANDREW 2 POST WAVEGUIDE BRIDGE

ANDREW 2 POST WAVEGUIDE BRID KIT (PART #: WB-K410-B15, OR APPROVED EQUIVALENT)

 $\binom{2}{C12}$

WAVEGUIDE BRIDGE DETAIL (ALT DESIGN - 2 PIPE COLUMNS)

NOT TO SCALE

verizon/

8921 RESEARCH DRIVE CHARLOTTE, NORTH CAROLINA 28262

> SITE NAME: LUTTERLOH SITE No.: 431701

PROJECT #: 20192010936 0 NC 87 N PITTSBORO, NC 27312 CHATHAM COUNTY

TPLANS PREPARED BY:


PROJECT INFORMATION:

KimleyMorn

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WAVEGUIDE BRIDGE DETAILS

SHEET NUMBER:

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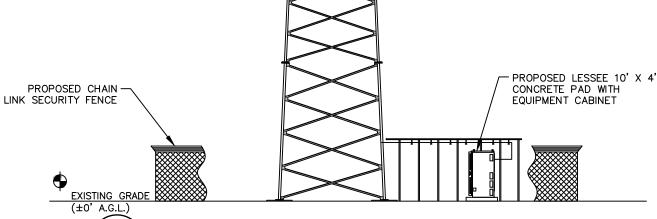
ANTENNA ORIENTATION PLAN

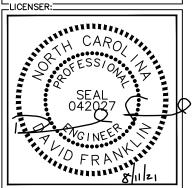(NOT TO SCALE, FOR ILLUSTRATIVE PURPOSES ONLY, SEE STRUCTURAL ANALYSIS BY OTHERS TO CONFIRM ANTENNA MOUNT TYPE)

- 1. REFER TO RFDS PROVIDED BY VERIZON. CONTRACTOR TO CONTACT THE VERIZON WIRELESS CONSTRUCTION MANAGER PRIOR TO CONSTRUCTION FOR THE CONSTRUCTION RFDS.
- 2. GENERAL CONTRACTOR TO INSTALL RAYCAP OVP, NUMBER AND TYPE PER VERIZON CONSTRUCTION MANAGER.
- 3. ANTENNA MOUNTING FRAMES MOUNTED TO PLATFORM HANDRAIL 4. SECTOR MOUNT TO BE KENWOOD TELECOM CIRCULAR PLATFORM FOR LATTICE TOWERS (PART #: T1515KT-G OR APPROVED EQUAL).
- 5. VERIZON TO ORDER TOWER WITH LEG SPACING OF 60" OR LESS AT SECTOR MOUNT MOUNTING LOCATION

1. ALL INFORMATION ON THIS PAGE IS PROVIDED BY VERIZON WIRELESS AND/OR OTHERS AND IS SHOWN FOR ILLUSTRATIVE PURPOSES ONLY. CONTRACTOR SHALL CONTACT THE VERIZON WIRELESS CONSTRUCTION MANAGER PRIOR TO CONSTRUCTION FOR ALL DETAILED ANTENNA, AND COAX CABLE INFORMATION.

- 2. REFER TO STRUCTURAL ANALYSIS BY TOWER OWNER FOR ANALYSIS OF PROPOSED TOWER.
- 3. IT IS UNDERSTOOD THAT KIMLEY-HORN MAKES NO WARRANTY, EITHER EXPRESSED OR IMPLIED, FINDINGS, DESIGNS, RECOMMENDATIONS, SPECIFICATIONS, OPINION, OR PROFESSIONAL ADVICE RELATING TO THE STRUCTURAL ADEQUACY OF THE PROPOSED TOWER OR ATTACHMENT OF ANTENNAS OR OTHER APPURTENANCES.



SELF-SUPPORT TOWER ELEVATION

BEACON PER FAA REQUIREMENETS.

TOP OF TOWER

EL. 255' A.G.L.

EXTEND BEACON ABOVE TOP OF ANTENNAS

PER VERIZON WIRELESS REQUIREMENTS.

NOT TO SCALE NOTES:

- 1. ALL PROPOSED ATTACHMENTS TO TOWER BASED ON TOWER DESIGN DRAWINGS BY OTHERS (SEE GENERAL NOTE 1.07, SHEET N1).
- 2. THE TOWER ELEVATION SHOWN IS FOR REFERENCE ONLY.
- 3. COAX/FIBER CABLE LENGTHS ARE APPROXIMATE. CONTRACTOR TO VERIFY CORRECT LENGTH IN FIELD AT TIME OF CONSTRUCTION.

TOP OF LIGHTNING ROD

♥ EL. 250' A.G.L.

FUTURE ANTENNAS

FUTURE ANTENNAS

FUTURE ANTENNAS

TOWER OBSTRUCTION LIGHTS

PROPOSED 255'

SELF SUPPORT TOWER

PROPOSED LESSEE ANTENNAS

EL. 264' A.G.L.

4. PROPOSED TOWER WILL BE GALVANIZED STEEL-GRAY IN COLOR.

verizon^v

PROJECT INFORMATION:

SITE NAME: LUTTERLOH SITE No.: 431701 PROJECT #: 20192010936

0 NC 87 N PITTSBORO, NC 27312 CHATHAM COUNTY

TPLANS PREPARED BY:

11720 AMBER PARK DRIVE, SUITE 600 ALPHARETTA, GA 30009 PHONE: 770-619-4280 WWW.KIMLEY-HORN.COM NC License F-0102

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0 07/12/21 CONSTRUCTION DMF

KHA PROJECT NUMBER:

013509278

DRAWN BY: CHECKED BY:

SHEET TITLE:

ANTENNA AND TOWER ELEVATION

DETAILS

SHEET NUMBER:

LEGEND

AMERICAN HOLLY

GENERAL LANDSCAPE NOTES:

- THE LANDSCAPE CONTRACTOR SHALL BE RESPONSIBLE FOR COORDINATION OF HIS WORK WITH THAT OF ALL OTHER CONTRACTORS. THIS PLAN DOES NOT GUARANTEE THE EXISTENCE OR NON-EXISTENCE OF ANY UTILITIES. PRIOR TO COMMENCEMENT OF ANY WORK, THE LANDSCAPE CONTRACTOR SHALL VERIFY THE LOCATIONS OF ALL ABOVE GROUND AND UNDERGROUND UTILITIES.
- THE QUALITY AND SIZE OF ALL PLANT MATERIAL SHALL CONFORM TO THE MOST CURRENT STANDARDS AS SET FORTH IN ANSI Z60.180 - AMERICAN STANDARD FOR NURSERY STOCK.
- 3. ALL DISTURBED AREAS NOT COVERED BY HARDSCAPE OR PLANT MATERIALS SHALL BE COVERED WITH SEED AND STRAW.
- PLANT SUBSTITUTION MAY BE PERMITTED ONLY AFTER PROOF THAT SPECIFIED PLANTS ARE UNAVAILABLE AND THE REQUEST HAS BEEN SUBMITTED TO THE OWNER OR LANDSCAPE ARCHITECT. THE CONTRACTOR SHALL PROVIDE THE NEAREST EQUIVALENT OBTAINABLE SIZE AND VARIETY OF THE PLANT HAVING THE SAME ESSENTIAL CHARACTERISTICS AS THE PLANT SPECIFIED
- MINOR PLANT LOCATION ADJUSTMENTS MAY BE MADE IN THE FIELD TO ENSURE ACCESS TO UTILITY JUNCTION BOXES, FREE SITE LIGHTING OF FUTURE TREE CANOPY INTERFERENCE AND ALLOW UNINHIBITED PEDESTRIAN / VEHICULAR CIRCULATION ON ALL PAVEMENTS OR FOUNDATIONS.
- ALL SHRUB MASSES OF TWO OR MORE SHALL BE EDGED INTO A PLANTING BED AND MULCHED PER DETAIL. ALL INDIVIDUAL TREES AND SHRUBS SHALL HAVE A MULCH SAUCER EQUAL IN DIAMETER TO THE PLANTING PIT DIAMETER AND SHALL BE MULCHED AS SHOWN ON THE DETAILS. UNLESS OTHERWISE INDICATED, ALL BED EDGES SHALL BE A DEEP CUT CLEAN SPADE EDGE.
- 7. THE CONTRACTOR SHALL VERIFY THAT EACH TREE OR SHRUB PIT WILL DRAIN BEFORE INSTALLING PLANT MATERIAL. HE SHALL FILL THE HOLE WITH SIX INCHES (6") OF WATER THAT SHOULD PERCOLATE OUT WITHIN TWENTY-FOUR HOURS. SHOULD ANY AREA NOT DRAIN PROPERLY, A PERFORATED DRAIN LINE SHALL BE INSTALLED, OR THE PLANTS RELOCATED.
- THE CONTRACTOR SHALL NOTIFY THE OWNER IMMEDIATELY IF HE ENCOUNTERS ANY UNSUITABLE SURFACE OR SUBSURFACE DRAINAGE CONDITIONS, SOIL DEPTH, LATENT SOILS, HARD PAN, UTILITY LINES, OR OTHER CONDITIONS THAT WILL JEOPARDIZE THE HEALTH AND VIGOR OF THE PLANTS. SHOULD THE CONTRACTOR NOT NOTIFY THE OWNER OF A PROBLEM AREA, HE WARRANTS THAT THE AREAS ARE SUITABLE FOR PROPER GROWTH AND DEVELOPMENT OF ALL
- 9. THE CONTRACTOR SHOULD VERIFY LANDSCAPING/TREE PLANTING LOCATIONS WITH THE PUBLIC UTILITIES DEPARTMENT TO AVOID CONFLICTS WITH WATER, SEWER, AND GAS LINES.
- 10. PLANTS SHALL BE SO TRAINED IN DEVELOPMENT AND APPEARANCE AS TO BE UNQUESTIONABLE SUPERIOR IN FORM. COMPACTNESS AND SYMMETRY. THEY SHALL BE SOUND. HEALTHY, VIGOROUS, WELL BRANCHED AND DENSELY FOLIATED WHEN IN LEAF, AND FREE OF DISEASE AND INSECT ADULT EGGS, PUPAE OR LARVAE. THEY SHALL HAVE HEALTHY, WELL-DEVELOPED ROOT SYSTEMS AND SHALL BE FREE FROM PHYSICAL DAMAGE OR OTHER CONDITIONS THAT WOULD PREVENT THRIVING GROWTH.
- 11. THERE SHALL BE NO CIRCLING OR GIRDLING ROOTS. CIRCLING ROOTS SHOULD BE CUT IN AT LEAST ONE PLACE.
- 12. THERE SHOULD BE ONE DOMINANT LEADER TO THE TOP OF THE TREE WITH THE LARGEST BRANCHES SPACED AT LEAST 6 INCHES APART. THERE CAN BE TWO LEADERS IN THE TOP 10% OF THE TREE IF IT IS OTHERWISE OF GOOD QUALITY.
- 13. THE TREE CANOPY SHOULD BE SYMMETRICAL AND FREE OF LARGE VOIDS. CLEAR TRUNK SHOULD BE NO MORE THAN 40% OF TREE HEIGHT UNLESS OTHERWISE SPECIFIED IN THE PLANTING SPECIFICATIONS. CLEAR TRUNK SHALL BE OF SUFFICIENT HEIGHT TO CLEAR SURROUNDING USES THAT MAY BE IMPACTED BY THE FUTURE GROWTH OF THE TREE.
- 14. OPEN TRUNK AND BRANCH WOUNDS SHALL BE LESS THAN 10% OF THE CIRCUMFERENCE AT THE WOUND AND NO MORE THAN 2 INCHES TALL, PROPERLY MADE PRUNING CUTS ARE NOT CONSIDERED OPEN TRUNK WOUNDS. THERE SHOULD BE NO CONKS OR BLEEDING, AND THERE SHOULD BE NO SIGNS OF INSECTS OR DISEASE ON MORE THAN 5% OF THE TREE.
- 15. IF ANY OF THE ABOVE CONDITIONS ARE NOT MET, TREES MAY BE REJECTED.
- 16. TREE PROTECTION DEVICES MUST BE INSTALLED AND INSPECTED PRIOR TO ANY CLEARING, GRUBBING, OR GRADING OF THE SITE BY THE LOCAL ARBORIST.

| PLANTING LIST | | | | | | |
|---------------|------|---------------------|-------------------|---------------|--------------------|----------|
| | QTY. | QTY. BOTANICAL NAME | COMMON NAME | SPECIFICATION | | |
| SYM./KEY | | | | ROOT | PLANTING HEIGHT | SPACING |
| ТО | 32 | IIEX OPACA | AMERICAN HOLLY | B&B | 4'-5' | 10' O.C. |



PROJECT INFORMATION:

SITE NAME: LUTTERLOH SITE No.: 431701 PROJECT #: 20192010936 0 NC 87 N PITTSBORO, NC 27312


CHATHAM COUNTY

TPLANS PREPARED BY:

11720 AMBER PARK DRIVE SUITE 600 WWW.KIMLEY-HORN.COM

REV: DATE: ISSUED FOR: BY: 2 | 08/11/21 | CONSTRUCTION | DMF 1 07/19/21 CONSTRUCTION DMF 0 07/12/21 CONSTRUCTION DMF

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LANDSCAPING PLAN

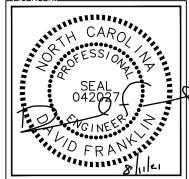SHEET NUMBER: