CONSTRUCTION PLANS FOR SEAFORTH PLACE

CHATHAM COUNTY, NORTH CAROLINA JULY 27, 2020

GENERAL CONSTRUCTION NOTES

- EXISTING UNDERGROUND STRUCTURES AND UTILITIES SHOWN ARE BASED ON FIELD SURVEYS AND BEST AVAILABLE RECORD DRAWINGS. THE CONTRACTOR SHALL FIELD VERIFY CONDITIONS, INCLUDING THE HORIZONTAL AND VERTICAL LOCATION OF ALL UTILITIES, PRIOR TO STARTING CONSTRUCTION AND NOTIFY THE ENGINEER OF ANY
- THE CONTRACTOR SHALL CONTACT NORTH CAROLINA ONE CALL AT 1-800-632-4949. THE CONTRACTOR SHALL CALL AT LEAST 48 HOURS PRIOR
- THE SUBJECT PROPERTY IS LOCATED IN ZONE X, A MINIMAL FLOOD RISK AREA PER FEMA FIRM PANEL 0608, MAP NUMBER 3720060800K, DATED 02/02/07 AND PANEL 9699, MAP NUMBER 3710969900K, DATED 11/17/17.
 IN-STREAM WORK SHALL BE PROHIBITED FROM MARCH 15 THROUGH JUNE
- 5. TOPOGRAPHIC INFORMATION PROVIDED BY CE GROUP, INC. RALEIGH, NC. PROFILE DATA FROM FIELD SURVEY, AND BACKGROUND TOPOGRAPHY FROM AERIAL MAPPING.
- 6. DISTURBANCE IS LIMITED TO NO MORE THAN 15 AC OF GRADUAL SLOPED LAND AT ANY ONE TIME (0 14.9% SLOPE).
- DISTURBANCE IS LIMITED TO NO MORE THAN 10 AC OF MODERATELY SLOPED LAND AT ANY ONE TIME (15 – 24.9% SLOPE).
 NCDOT ASSUMES NO RESPONSIBILITY FOR OPERATION, MAINTENANCE OR
- LIABILITY OF THE STRUCTURAL STORMWATER BMP'S OR ANY DRAINAGE OUTSIDE OF THE RIGHTS-OF-WAY.

 9. ALL GRATED INLETS IN DITCHES ARE TO BE NCDOT STD 840.22 OR 840.20 WIDE SLOT GRATES. JB#C5 TO BE A NCDOT STD 840.17 OR 840.26 TYPE A
- 2GI NARROW SLOT INLET.

 10. ALL PROPOSED UTILITIES INSIDE THE PROPOSED SUBDIVISION ROAD RIGHT OF WAY SHALL BE INSTALLED PER THE LATEST NCDOT POLICIES AND PROCEDURES FOR ACCOMMODATING UTILITIES ON HIGHWAY RIGHTS OF WAY AND ANY LATER NCDOT PUBLISHED GUIDELINES. NO UTILITY SHOULD BE INSTALLED IN THE SHOULDER, INSIDE THE PAVEMENT, OR INSIDE THE
- DITCHLINE. MAINTAIN CLEAR ZONE MINIMUM OFFSETS FOR
 NON-BREAKWAY UTILITY POLES.

 11. GUARDRAIL INSTALLATION SHALL BE IN ACCORDANCE WITH SECTION 862
 OF NCDOT CURRENT ROADWAY STANDARD DRAWINGS. CONTRACTOR TO
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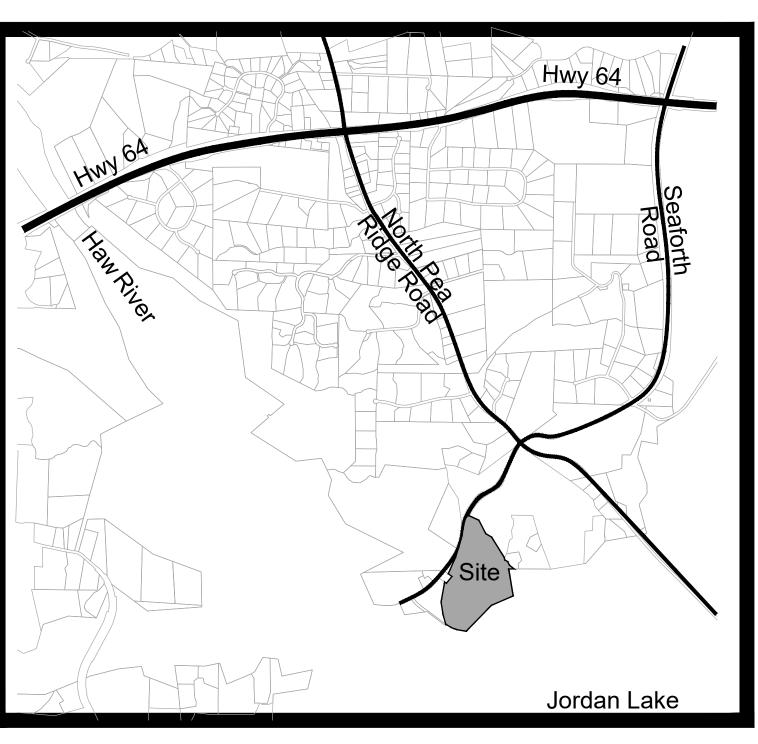
 12. ABC SHALL BE CONSTRUCTED IN ACCORDANCE WITH SECTION 520 OF THE LATEST NCDOT STANDARD SPECIFICATIONS FOR ROADS AND STRUCTURES.

Project Data:
Zoned: R-1 & R-5
AKPAR: 91403
PIN: 9771-00-82-4556
Watershed Classification: WS-IV NSW (P&C)
Total Parcel Acreage ± 64.10 Ac.
Length of Streets: ± 1,829 LF

Owner/Developer:
Swain Land & Timber, LLC
117 Edinburg Dr., Suite 101
Cary, NC 27511
Contact: Hadley Kirkland
Phone: 919.417.2990
Email: hadley@swainco.com

Civil Engineer / Surveyor:
CE Group, Inc
301 Glenwood Avenue, Suite 220
Raleigh, NC 27603
Phone: 919.367.8790
Contact: Jeff Foster, PE
Email: jeff@cegroupinc.com

Environmental Engineer:
Soil & Environmental Consultants, PA
8412 Falls Of Neuse Road, Suite 104
Raleigh, NC 27615
Phone: 919.846.5900
Contact: Steven Bail
Email: sball@sandec.com



VICINITY MAP

NORTH

INDEX TO DRAWINGS

LOT AREA IN R-1:

R-1 AVERAGE LOT SIZE:

R-1 LOTS:

COVER	C-01
EX COND & DEMO PLAN	EX-01
OVERALL SITE PLAN.	OS-01
OVERALL EROSION CONTROL KEY	OE-01
EROSION CONTROL PLAN STAGE1	EC-01 TO EC-02
EROSION CONTROL PLAN STAGE2	EC-03 TO EC-04
GRADING & DRAINAGE PLAN	GD-01 TO GD-02
SEAFORTH PLACE DR PP1	RW-01 TO RW-02
WATER QUALITY POND #1 PLAN	WQ-01
WATER QUALITY POND #2 PLAN	WQ-02
EROSION CONTROL DETAILS	ED-01 TO ED-03
EC SPECIFICATIONS	ED-04
EC MATERIALS & INSPECTION	ED-05
STORMWATER DETAILS	SD-01 TO SD-02
ROADWAY DETAILS	RD-01

SITE DATA:


ONED:	R-1 & R-5
KPAR:	91403
N:	9771-00-82-4556
ATERSHED:	WS-IV-NSW (P&C)
OTAL AREA:	64.10 Ac.
REA IN ROW (SEAFORTH RD):	0.617 Ac.
REA IN NEW PUBLIC ROW:	2.618 Ac.
OTAL PARCEL AREA:	61.936 Ac.
OTAL LOTS:	± 17 LOTS
OT AREA IN R-5:	± 42.19 Ac.
-5 LOTS:	8 LOTS
-5 AVERAGE LOT SIZE:	± 5.27 Ac.

± 19.26 Ac.

9 LOTS

± 2.14 Ac.

FRONT LOT SETBACK: 40'
SIDE AND REAR LOT SETBACK: 25'
LENGTH OF ROADS: ± 1,829 LI

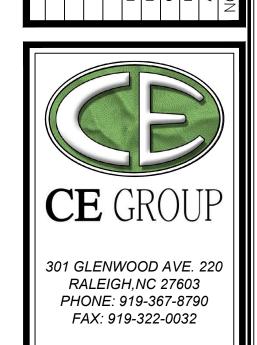

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CONSTRUCTION PLANS FOR SEAFORTH PLACE

Date:
JULY 27, 2020

Scale:
N/A

Drawn:
JWA

Checked:
JRF

Project No.
I 24-02







Computer Dwg. Name
24-02_01-c-01_cover



GENERAL CONSTRUCTION NOTES EXISTING UNDERGROUND STRUCTURES AND UTILITIES SHOWN ARE BASED ON FIELD SURVEYS AND BEST AVAILABLE RECORD DRAWINGS. THE CONTRACTOR SHALL FIELD VERIFY CONDITIONS, INCLUDING THE

IPF & Aluminum Disk

USACE Monument # 157-10-01

E: 1,977,619.62'

Horizontal Datum NAD/83 (2011)

Vertical Datum: NAVD/88 (Geoid 12B)

HORIZONTAL AND VERTICAL LOCATION OF ALL UTILITIES, PRIOR TO STARTING CONSTRUCTION AND NOTIFY THE ENGINEER OF ANY DISCREPANCIES. 2. THE CONTRACTOR SHALL CONTACT NORTH CAROLINA ONE CALL AT 1-800-632-4949. THE CONTRACTOR SHALL CALL AT LEAST 48 HOURS PRIOR

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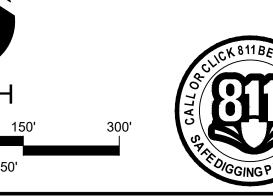
301 GLENWOOD AVE. 220 RALEIGH,NC 27603 PHONE: 919-367-8790 FAX: 919-322-0032

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LEGEND	
FIREHYDRANT (FH)	
STREET SIGN	
POWER POLE	
RCP=REINFORCED CONCRETE PIPE	
R/W = RIGHT-OF-WAY	
TYP = TYPICAL	
LF = LINEAR FEET	
INV = INVERT	
OHE = OVERHEAD ELECTRIC	
FES = FLARED END SECTION	
. ~~~~	TREELINE
	EXISTING 1' CONTOURS
	EXISTING 5' CONTOURS
	PROPERTY BOUNDARY







EX-01

Project No.

JULY 27, 2020



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 2GI NARROW SLOT INLET.

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SHALL BE MADE TO AVOID THE NEED FOR GUARDRAIL IN CONSTRUCTION

SITE DATA:

 ZONED:
 R-1 & R-5

 AKPAR:
 91403

 PIN:
 9771-00-82-4556

 WATERSHED:
 WS-IV-NSW (P&C)

 TOTAL AREA:
 64.10 Ac.

 AREA IN ROW (SEAFORTH RD):
 0.617 Ac.

 AREA IN NEW PUBLIC ROW:
 2.618 Ac.

 TOTAL PARCEL AREA:
 61.936 Ac.

TOTAL LOTS: ± 17 LOTS

 LOT AREA IN R-5:
 ± 42.19 Ac.

 R-5 LOTS:
 8 LOTS

 R-5 AVERAGE LOT SIZE:
 ± 5.27 Ac.


 LOT AREA IN R-1:
 ± 19.26 Ac.

 R-1 LOTS:
 9 LOTS

 R-1 AVERAGE LOT SIZE:
 ± 2.14 Ac.

FRONT LOT SETBACK: 40'
SIDE AND REAR LOT SETBACK: 25'
LENGTH OF ROADS: ± 1,829 LF



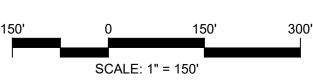



FINAL DESIGN

FOR CONSTRUCTION

E REVISIONS PER NCDOT HYDRAULICS COMMENTS
D REVISIONS PER NCDOT COMMENTS
C REVISIONS PER NCDOT COMMENTS
B REVISIONS PER EC & STORMWATER COMMENTS
A REVISIONS PER EC & STORMWATER COMMENTS
NO.



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FAX: 919-322-0032

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SEAL 028291

RALL SITE PLAN

Date:

JULY 27, 2020

Scale:

I" = 150'

Drawn:

JWA

Checked:


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Project No.

24-02_03-os-01_overall site plan
Sheet No:


124-02 omputer Dwg. Name



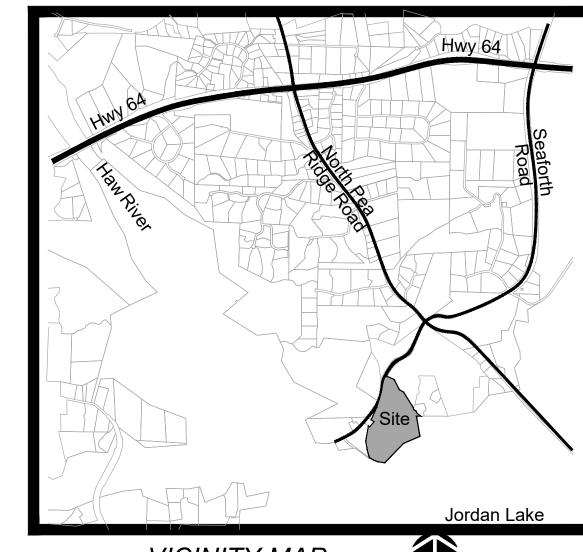

VICINITY MAP

DISTURBED AREA TOTAL = 8.0 AC.

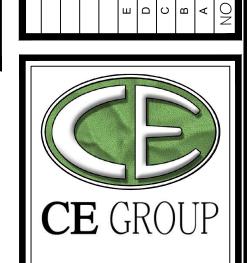

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OVERALL EROSION CONTROL CHATHAM COUNTY, NC

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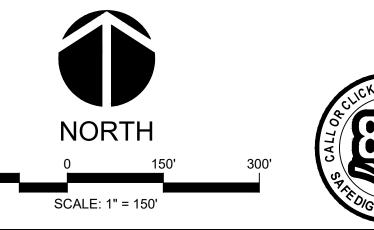
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FINAL DESIGN

FOR CONSTRUCTION

24-02_04-oe-01_overall erosion control

JULY 27, 2020

1" = 150'


JWA

JRF

124-02 Computer Dwg. Name

hecked:

Project No.

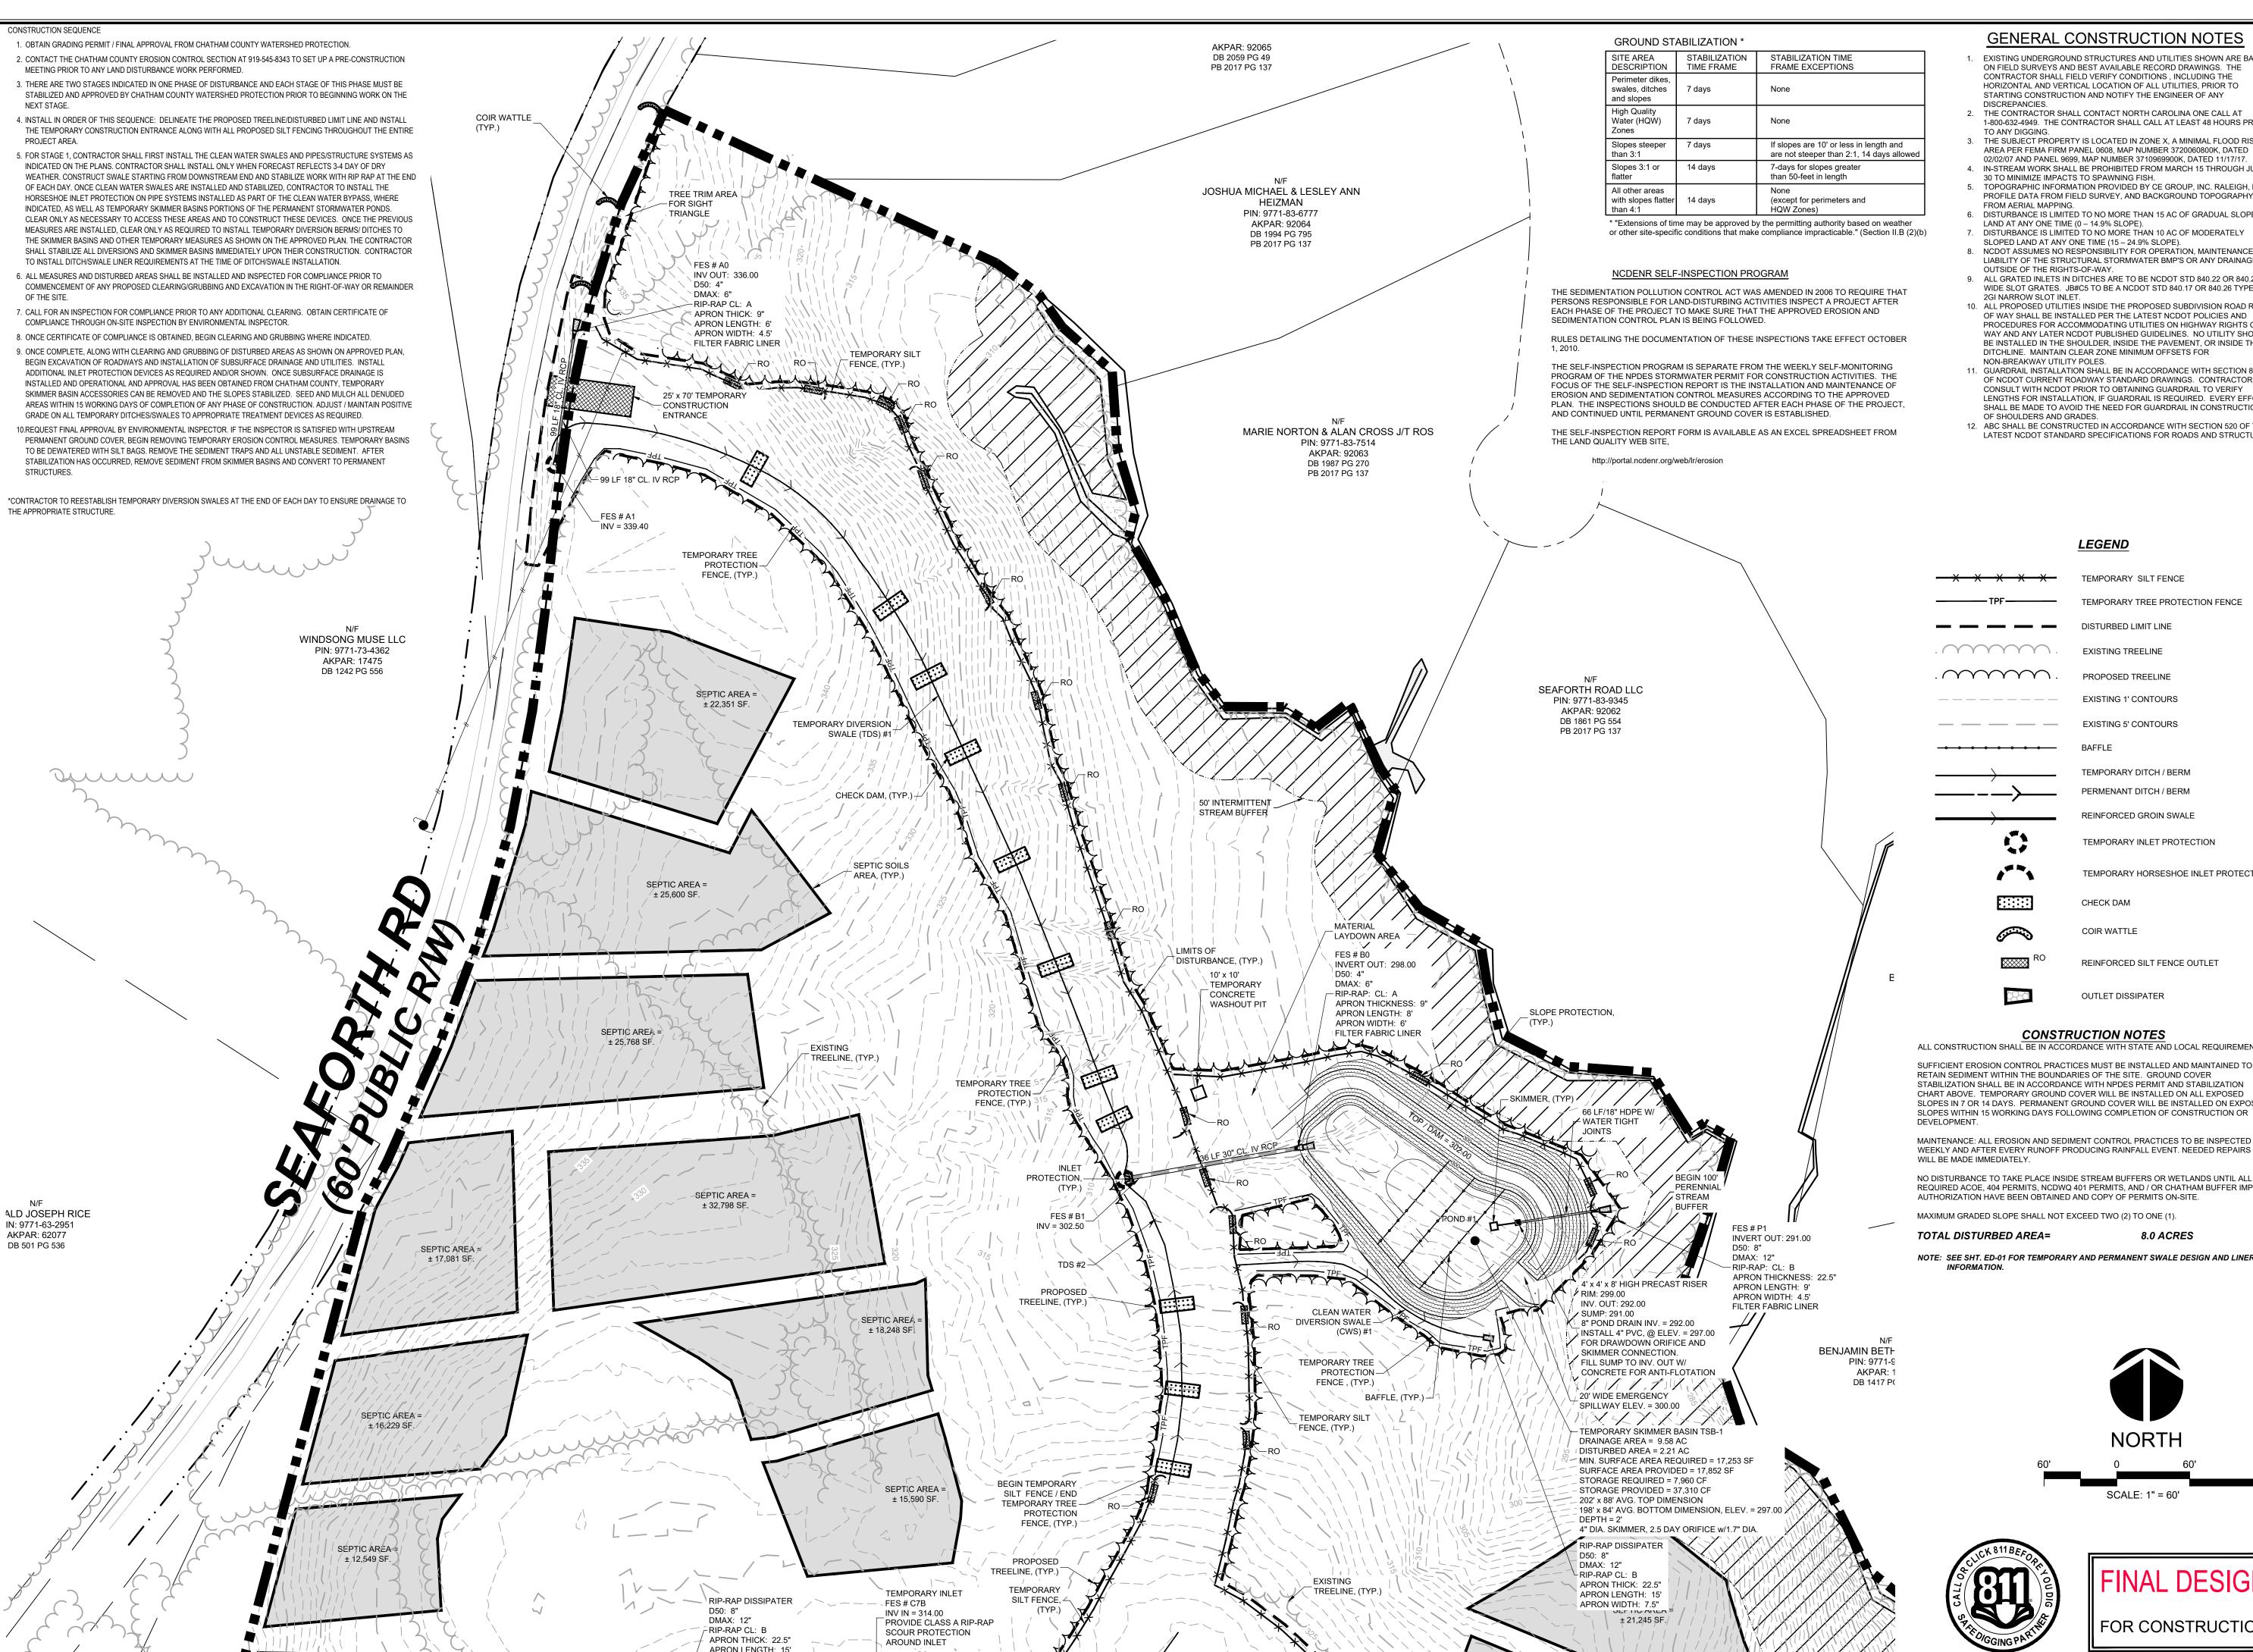

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LEGEND

TEMPORARY SILT FENCE TEMPORARY TREE PROTECTION FENCE DISTURBED LIMIT LINE

. PROPOSED TREELINE EXISTING 1' CONTOURS

— — EXISTING 5' CONTOURS

TEMPORARY DITCH / BERM PERMENANT DITCH / BERM REINFORCED GROIN SWALE

TEMPORARY INLET PROTECTION

TEMPORARY HORSESHOE INLET PROTECTIO

CHECK DAM

COIR WATTLE REINFORCED SILT FENCE OUTLET

OUTLET DISSIPATER

CONSTRUCTION NOTES


ALL CONSTRUCTION SHALL BE IN ACCORDANCE WITH STATE AND LOCAL REQUIREMENTS. SUFFICIENT EROSION CONTROL PRACTICES MUST BE INSTALLED AND MAINTAINED TO RETAIN SEDIMENT WITHIN THE BOUNDARIES OF THE SITE. GROUND COVER STABILIZATION SHALL BE IN ACCORDANCE WITH NPDES PERMIT AND STABILIZATION CHART ABOVE. TEMPORARY GROUND COVER WILL BE INSTALLED ON ALL EXPOSED SLOPES IN 7 OR 14 DAYS. PERMANENT GROUND COVER WILL BE INSTALLED ON EXPOSED

MAINTENANCE: ALL EROSION AND SEDIMENT CONTROL PRACTICES TO BE INSPECTED WEEKLY AND AFTER EVERY RUNOFF PRODUCING RAINFALL EVENT. NEEDED REPAIRS

NO DISTURBANCE TO TAKE PLACE INSIDE STREAM BUFFERS OR WETLANDS UNTIL ALL REQUIRED ACOE, 404 PERMITS, NCDWQ 401 PERMITS, AND / OR CHATHAM BUFFER IMPACT AUTHORIZATION HAVE BEEN OBTAINED AND COPY OF PERMITS ON-SITE.

TOTAL DISTURBED AREA=

NOTE: SEE SHT. ED-01 FOR TEMPORARY AND PERMANENT SWALE DESIGN AND LINER

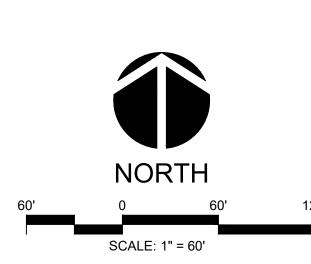



FOR CONSTRUCTION

301 GLENWOOD AVE. 220

RALEIGH,NC 27603 PHONE: 919-367-8790

FAX: 919-322-0032

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License # C-1739

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NOISO

JULY 27, 2020

1" = 60'

JRF


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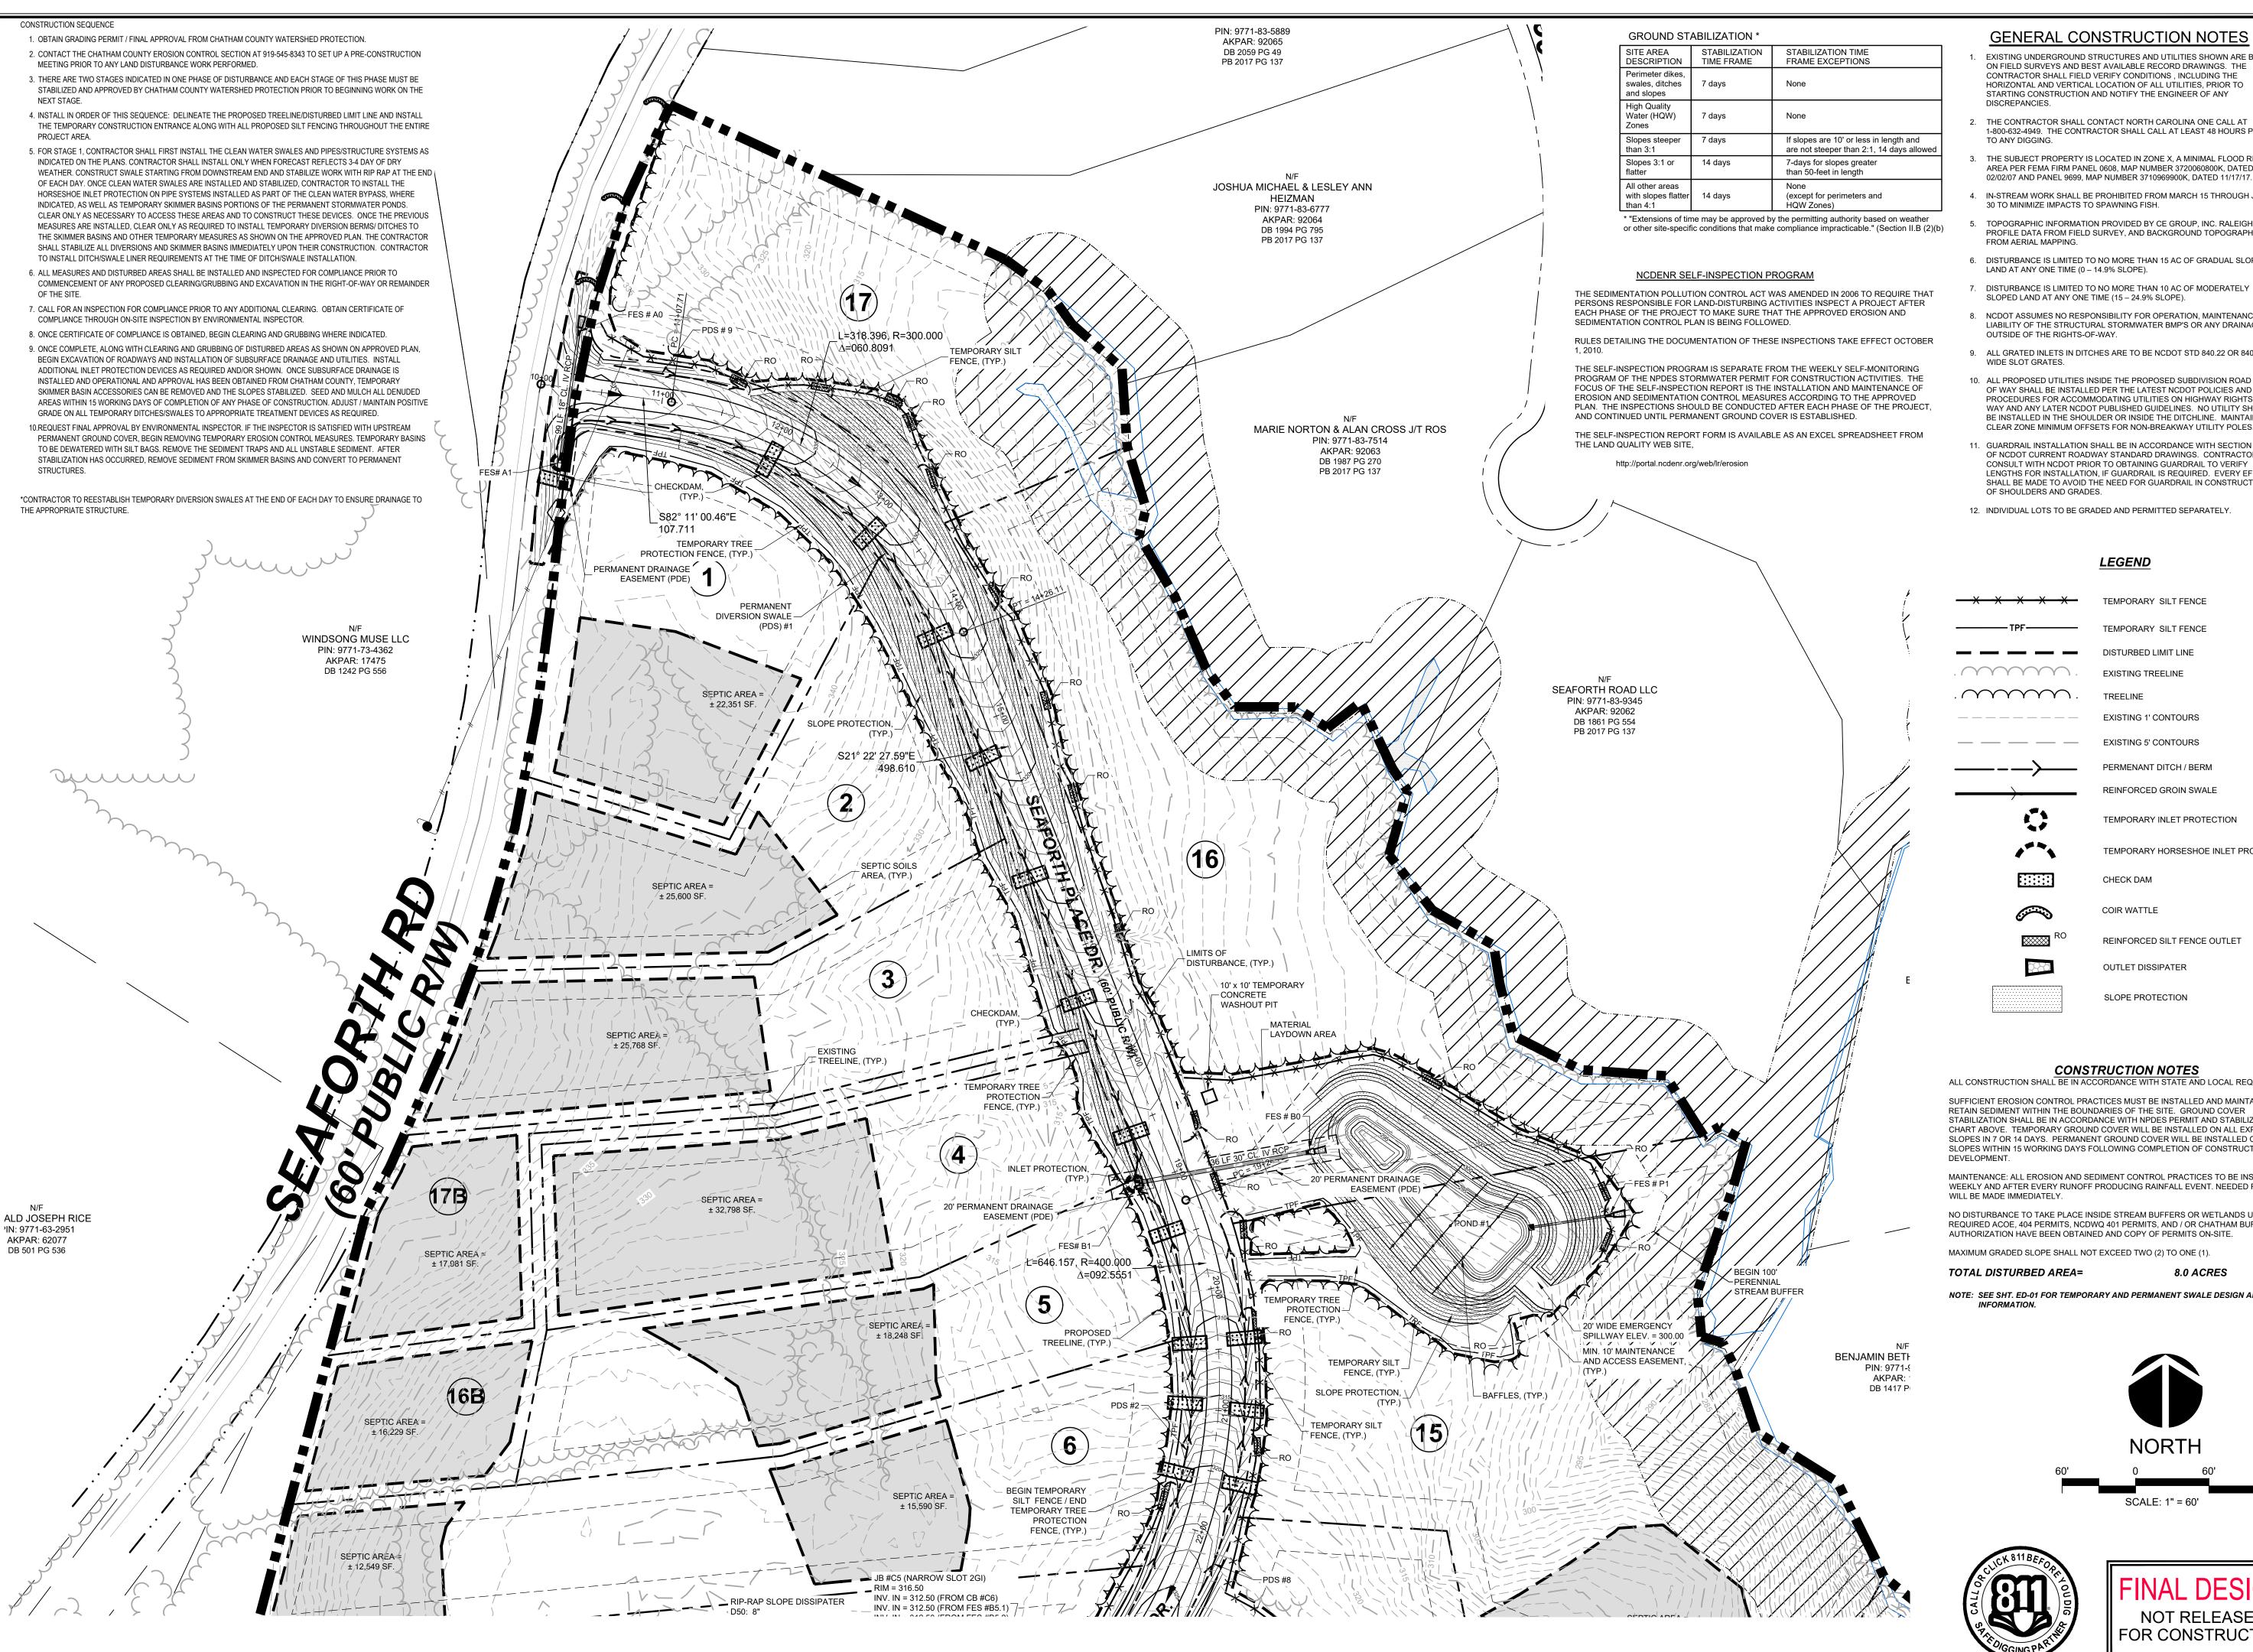
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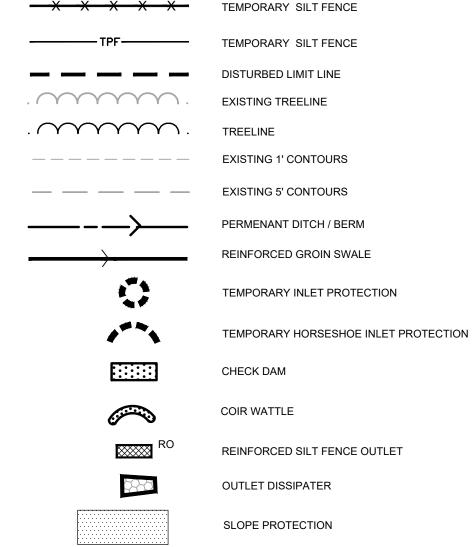




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- 8. NCDOT ASSUMES NO RESPONSIBILITY FOR OPERATION, MAINTENANCE OR LIABILITY OF THE STRUCTURAL STORMWATER BMP'S OR ANY DRAINAGE
- 9. ALL GRATED INLETS IN DITCHES ARE TO BE NCDOT STD 840.22 OR 840.20
- 10. ALL PROPOSED UTILITIES INSIDE THE PROPOSED SUBDIVISION ROAD RIGHT OF WAY SHALL BE INSTALLED PER THE LATEST NCDOT POLICIES AND PROCEDURES FOR ACCOMMODATING UTILITIES ON HIGHWAY RIGHTS OF WAY AND ANY LATER NCDOT PUBLISHED GUIDELINES. NO UTILITY SHOULD BE INSTALLED IN THE SHOULDER OR INSIDE THE DITCHLINE. MAINTAIN CLEAR ZONE MINIMUM OFFSETS FOR NON-BREAKWAY UTILITY POLES.
- 11. GUARDRAIL INSTALLATION SHALL BE IN ACCORDANCE WITH SECTION 862 OF NCDOT CURRENT ROADWAY STANDARD DRAWINGS. CONTRACTOR TO CONSULT WITH NCDOT PRIOR TO OBTAINING GUARDRAIL TO VERIFY LENGTHS FOR INSTALLATION, IF GUARDRAIL IS REQUIRED. EVERY EFFORT SHALL BE MADE TO AVOID THE NEED FOR GUARDRAIL IN CONSTRUCTION OF SHOULDERS AND GRADES.
- 12. INDIVIDUAL LOTS TO BE GRADED AND PERMITTED SEPARATELY.

LEGEND

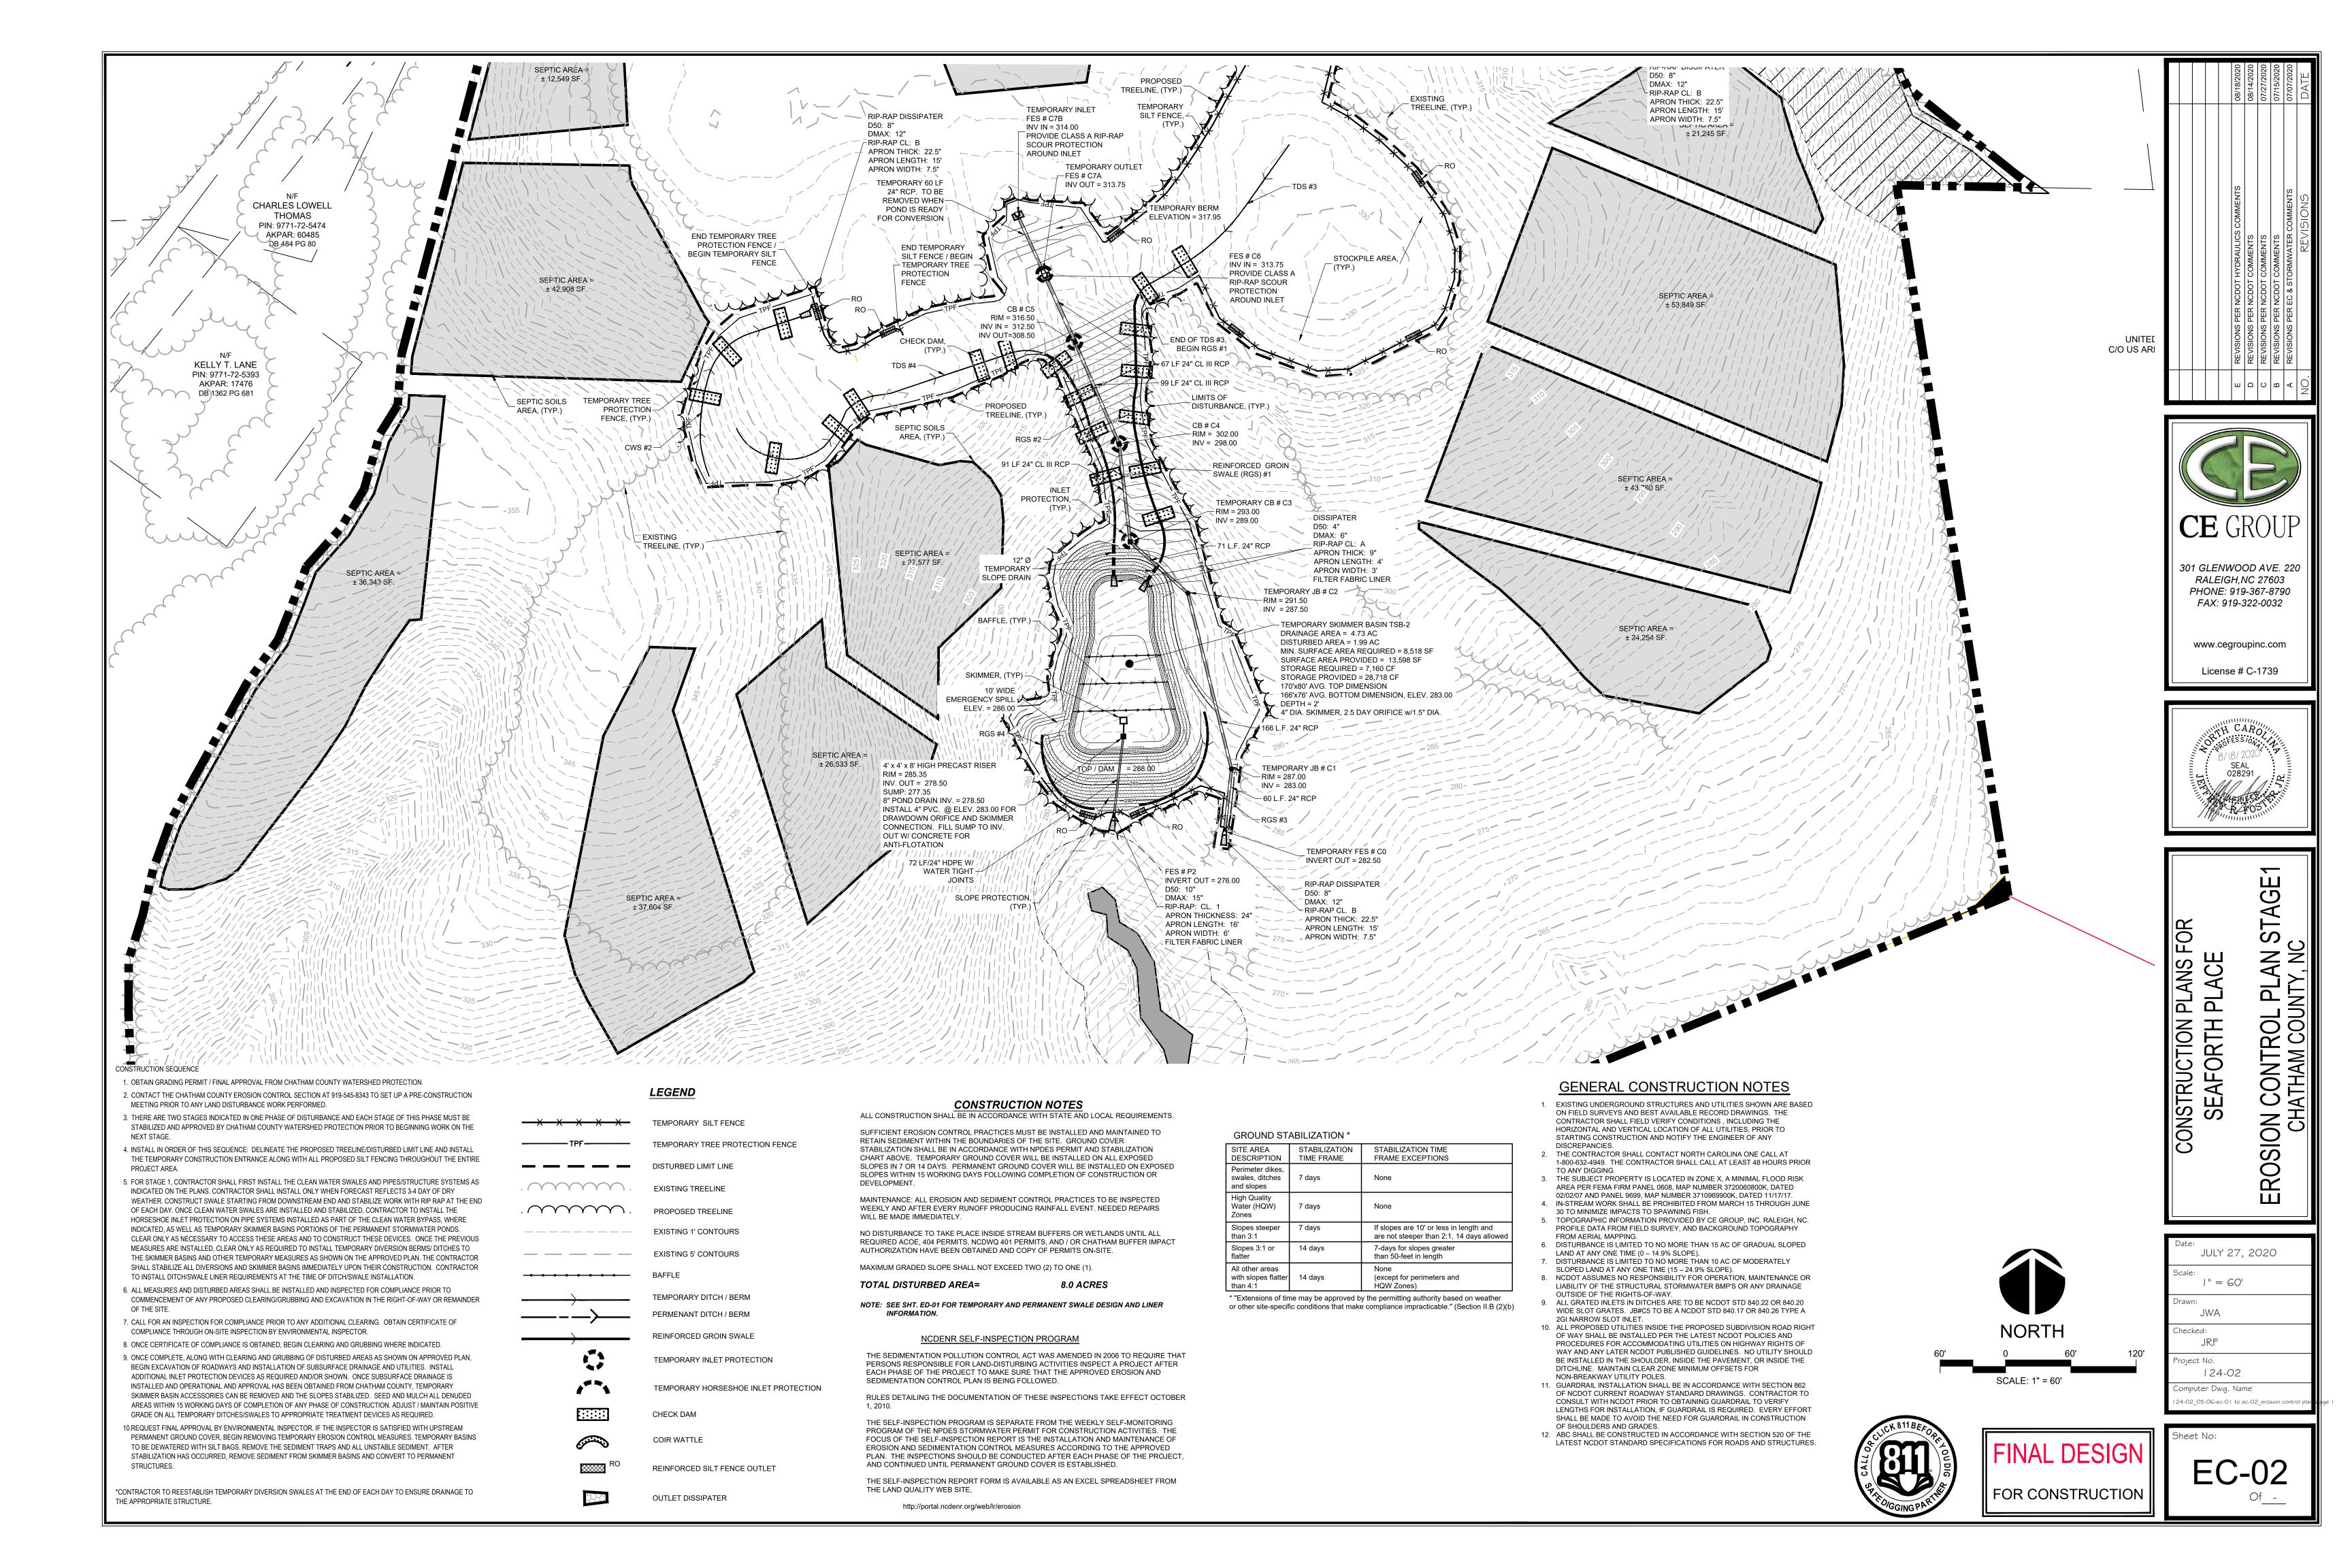

CONSTRUCTION NOTES

ALL CONSTRUCTION SHALL BE IN ACCORDANCE WITH STATE AND LOCAL REQUIREMENTS


SUFFICIENT EROSION CONTROL PRACTICES MUST BE INSTALLED AND MAINTAINED TO RETAIN SEDIMENT WITHIN THE BOUNDARIES OF THE SITE GROUND COVER STABILIZATION SHALL BE IN ACCORDANCE WITH NPDES PERMIT AND STABILIZATION CHART ABOVE. TEMPORARY GROUND COVER WILL BE INSTALLED ON ALL EXPOSED SLOPES IN 7 OR 14 DAYS. PERMANENT GROUND COVER WILL BE INSTALLED ON EXPOSED SLOPES WITHIN 15 WORKING DAYS FOLLOWING COMPLETION OF CONSTRUCTION OR

MAINTENANCE: ALL EROSION AND SEDIMENT CONTROL PRACTICES TO BE INSPECTED WEEKLY AND AFTER EVERY RUNOFF PRODUCING RAINFALL EVENT. NEEDED REPAIRS

NO DISTURBANCE TO TAKE PLACE INSIDE STREAM BUFFERS OR WETLANDS UNTIL ALL REQUIRED ACOE, 404 PERMITS, NCDWQ 401 PERMITS, AND / OR CHATHAM BUFFER IMPACT AUTHORIZATION HAVE BEEN OBTAINED AND COPY OF PERMITS ON-SITE.

MAXIMUM GRADED SLOPE SHALL NOT EXCEED TWO (2) TO ONE (1). TOTAL DISTURBED AREA= 8.0 ACRES

NOTE: SEE SHT. ED-01 FOR TEMPORARY AND PERMANENT SWALE DESIGN AND LINER

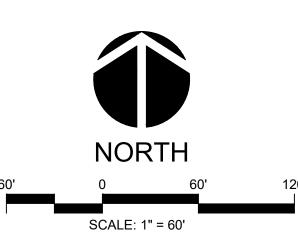



NOT RELEASED FOR CONSTRUCTION

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JULY 27, 2020

1" = 60'

JRF

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