## WETLAND PLANTING INSTRUCTIONS

- A SOIL ANALYSIS SHOULD BE CONDUCTED WITHIN THE STORMWATER WETLAND TO DETERMINE
  THE VIABILITY OF SOILS FOR HEALTHY VEGETATION GROWTH. IMPORTED OR IN—SITU SOILS MAY
  BE AMENDED WITH ORGANIC MATERIAL, DEPENDING ON SOIL ANALYSIS RESULTS, TO ENHANCE
- SUITABILITY AS A PLANTING MEDIA.


  2. CONFIRM ELEVATIONS FOR SHALLOW WATER AND TEMPORARY INUNDATION ZONES PRIOR TO PLANTING. ADJUSTMENTS TO PLANT LOCATIONS MAY BE REQUIRED BASED ON BUILT
- CONDITIONS. SURVEYED PLANTING ZONES SHOULD BE MARKED ON AN "AS—BUILT" OR RECORD DESIGN PLAN AND LOCATED IN THE FIELD USING STAKES OR FLAGS.

  3. INSTALL PLANTS IN GROUPS OF 50 TO 60. DISTRIBUTE GROUPINGS EVENLY WITHIN SPECIFIED
- 4. PLANT AT 24" ON CENTER MAXIMUM.5. PERIODIC WATERING MAY BE REQUIRED UNTIL PLANTS ARE ESTABLISHED.

| PLANT LIST    |                           |                  |                              |                           |  |  |  |  |  |  |
|---------------|---------------------------|------------------|------------------------------|---------------------------|--|--|--|--|--|--|
| QTY.<br>TÖTAL | BOTANICAL NAME            | COMMON NAME      | SIZE                         | PLANTING ZONE             |  |  |  |  |  |  |
|               | TEMPORARY INUNDATION ZONE |                  |                              |                           |  |  |  |  |  |  |
| 150           | ASCLEPIAS INCARNATA       | SWAMP MILKWEED   | LARGE PLUG                   | TEMPORARY INUNDATION ZONE |  |  |  |  |  |  |
| 150           | CAREX LURIDA              | SHALLOW SEDGE    | LARGE PLUG                   | TEMPORARY INUNDATION ZONE |  |  |  |  |  |  |
| 150           | EUTROCHIUM FISTULOSUS     | JOE PYE WEED     | LARGE PLUG                   | TEMPORARY INUNDATION ZONE |  |  |  |  |  |  |
| 150           | LOBELIA ELONGATA          | LONGLEAF LOBELIA | LARGE PLUG                   | TEMPORARY INUNDATION ZONE |  |  |  |  |  |  |
| 150           | SCIRPUS CYPERINUS         | WOOLGRASS        | LARGE PLUG                   | TEMPORARY INUNDATION ZONE |  |  |  |  |  |  |
|               | SHALLOW WATER             |                  |                              |                           |  |  |  |  |  |  |
| 100           | IRIS VIRGINICA            | BLUE FLAG IRIS   | 9" HEIGHT (SEE NOTE 1 BELOW) | SHALLOW WATER             |  |  |  |  |  |  |
| 150           | PELTANDRA VIRGINICA       | ARROW ARUM       | 9" HEIGHT (SEE NOTE 1 BELOW) | SHALLOW WATER             |  |  |  |  |  |  |
| 150           | PONTEDERIA CORDATA        | PICKERELWEED     | 9" HEIGHT (SEE NOTE 1 BELOW) | SHALLOW WATER             |  |  |  |  |  |  |
| 100           | SAGITTARIA LANCIFOLIA     | BULLTONGUE       | 9" HEIGHT (SEE NOTE 1 BELOW) | SHALLOW WATER             |  |  |  |  |  |  |
| 150           | SAURURUS CERNUUS          | LIZARD'S TAIL    | 9" HEIGHT (SEE NOTE 1 BELOW) | SHALLOW WATER             |  |  |  |  |  |  |

## PLANT NOTES:


- 1. PLANTS THAT GROW IN SHALLOW WATER (WATER'S EDGE TO 6" BELOW NORMAL WATER LEVEL) MUST HAVE AT LEAST 3" OF ABOVE—WATER FOLIAGE WHEN INSTALLED. THIS CAN BE ACHIEVED BY ADJUSTING THE WATER LEVEL OF THE WETLAND TO ACCOMMODATE PLANTS WITH SHORTER FOLIAGE OR BY SPECIFYING THAT PLANTS MUST HAVE AT LEAST A 9" FOLIAGE HEIGHT WHEN INSTALLED IN THIS ZONE. SMALLER SHALLOW WATER PLANTS MAY BE USED IF NORMAL WATER LEVEL IS TEMPORARILY ADJUSTED UNITL PLANTS ARE ESTABLISHED, THEN WATER LEVEL MUST BE RETURNED TO DESIGN ELEVATION. TEMPORARY ADJUSTMENT TO WATER LEVEL MUST BE APPROVED BY THE ENGINEER AND
- 2. SUBSTITUTIONS TO THE PLANT LIST MAY BE MADE FOR AVAILABILITY PURPOSES. SUBSTITUTIONS MUST BE APPROVED BY THE LANDSCAPE ARCHITECT AND BE ON THE APPROVED PLANT LIST FOR THE CORRESPONDING PLANTING ZONE FOUND IN THE NCDEQ STORMWATER DESIGN MANUAL FOR CONSTRUCTED WETLAND (C-4).
- 3. THE MOST COMMON AND RELIABLE TECHNIQUE FOR ESTABLISHING AN EMERGENT WETLAND COMMUNITY IN A STORMWATER WETLAND IS TO TRANSPLANT NURSERY STOCK OBTAINED FROM LOCAL AQUATIC PLANT NURSERIES. THE OPTIMAL PERIOD FOR TRANSPLANTING EXTENDS FROM EARLY APRIL TO MID—JUNE SO THAT THE WETLAND PLANTS WILL HAVE A FULL GROWING SEASON TO BUILD THE ROOT RESERVES NEEDED TO SURVIVE THE WINTER. HOWEVER, SOME SPECIES MAY BE PLANTED SUCCESSFULLY IN EARLY FALL. CONTACT YOUR NURSERY WELL IN ADVANCE OF CONSTRUCTION TO ENSURE THAT THEY WILL HAVE THE DESIRED SPECIES AVAILABLE.

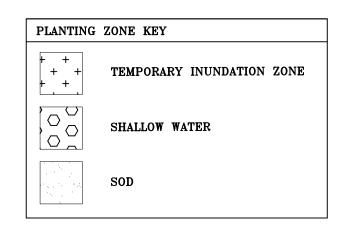



STORMWATER WETLAND CALCULATIONS

TEMPORARY INUNDATION ZONE
50 HERBACEOUS PLANTS PER 200 SF
2,910 SF / 200 = 14.55
14.55 X 50 = 728 REQ'D (750 PROVIDED)

SHALLOW WATER
50 HERBACEOUS PLANTS PER 200 SF
2,530 SF / 200 = 12.65
12.65 X 50 = 633 REQ'D (650 PROVIDED)

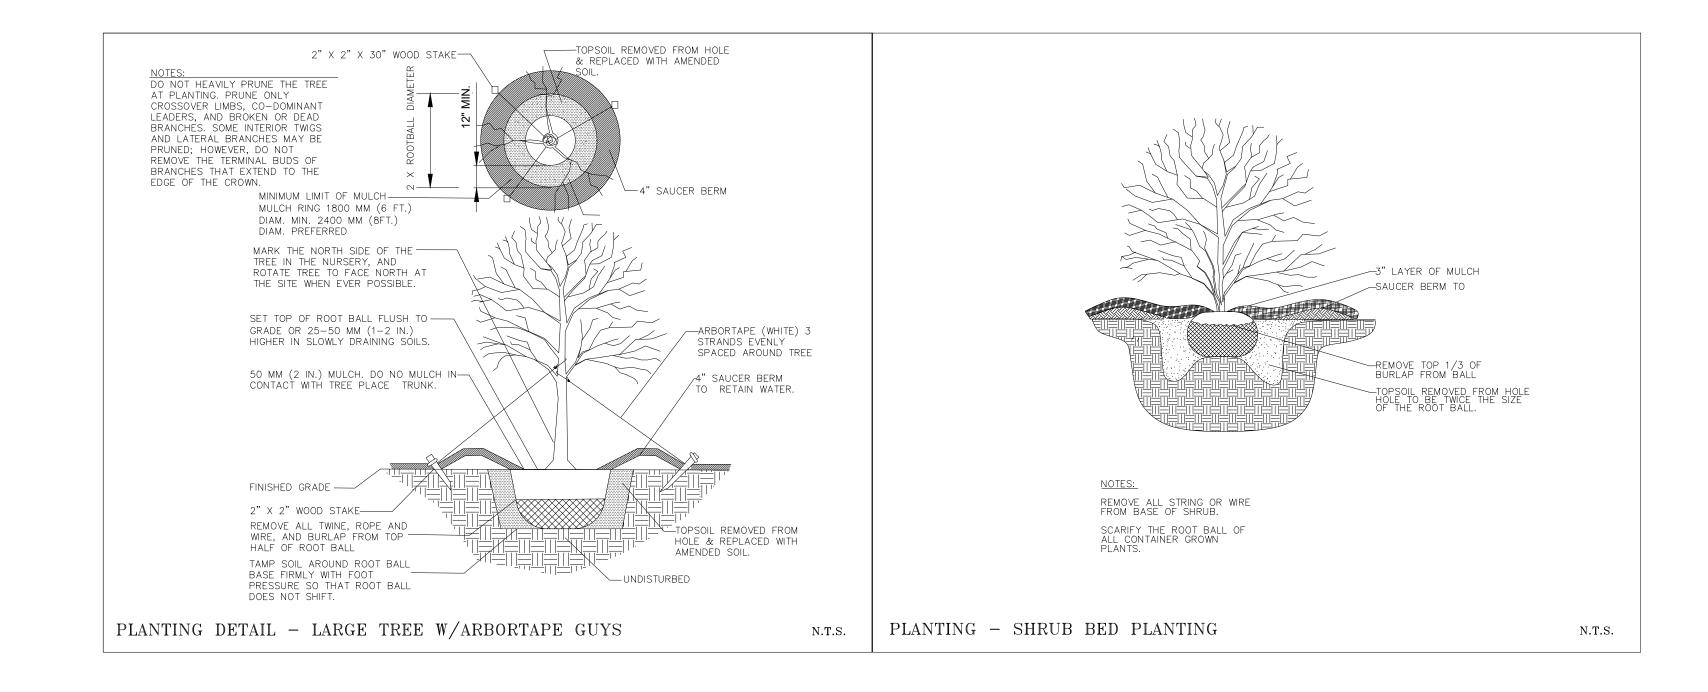

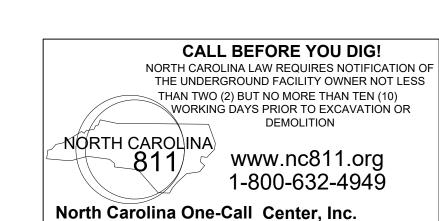

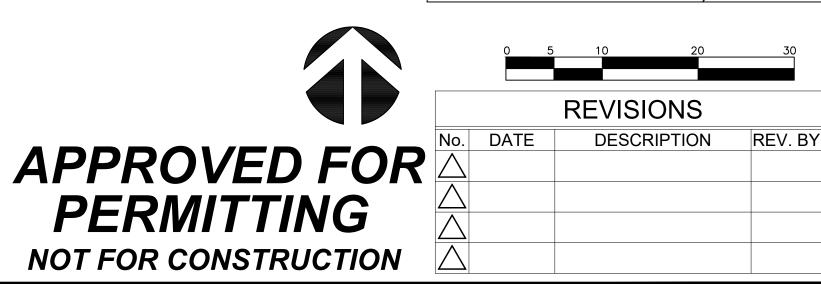

think, design, buil

ESIGN • BUIL 1

600 Germantown Road | Raleigh, North Carolina 27

Ph (919) 851-1980 | Fx (919) 851-1982 | design@bobb

COORDINATOR: Blair Pittman

DRAWN BY: Jason Galloway

CHK BY:BPP

DIMMUNITY CHURCH


24 X 36 1" = 10'

PROGRESS 18-0347

18-0347

LANDSCAPE
PLAN

C5.1

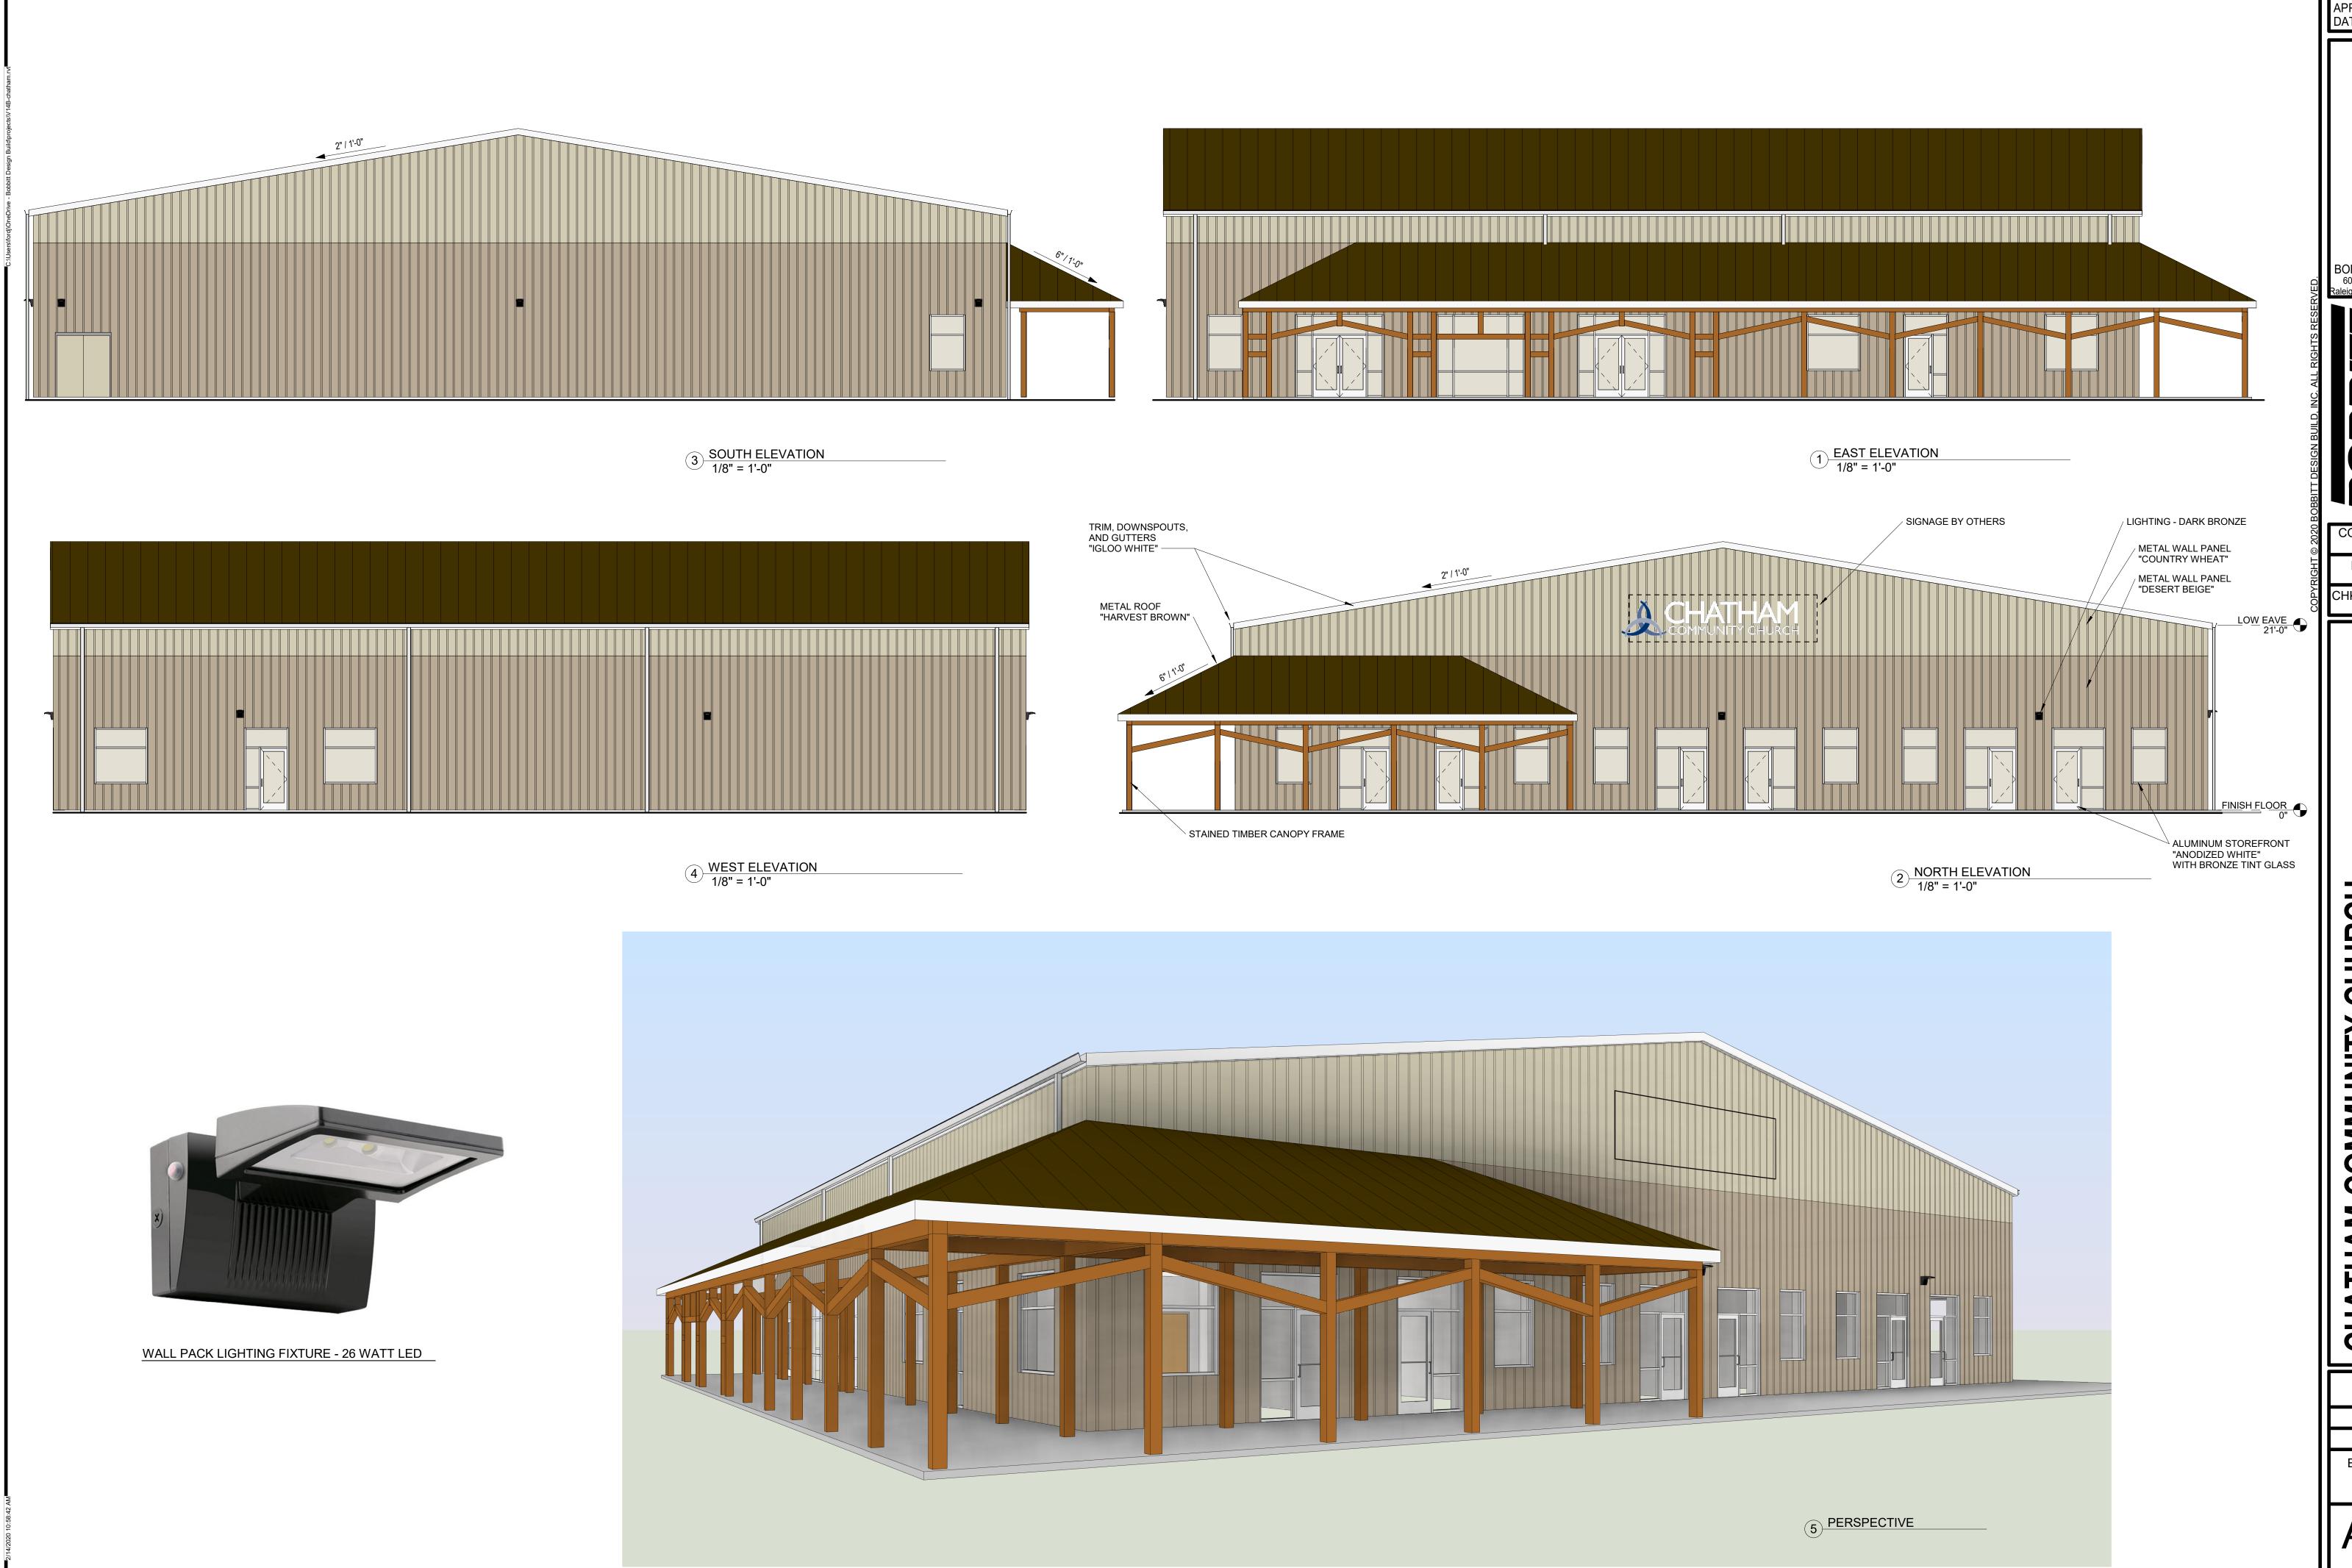

BOBBITT A&E, PLLC 600 Germantown Road Raleigh, North Carolina 27607

COORDINATOR: DRAWN BY: JGF

CHK BY: -

CHURCH

CHATHAM COMMUNITY CANDREWS STORE ROAD PITTSBORO, NC

24 X 36 As indicated 02/14/20

18-0347 **ELEVATIONS** 

A4.1



SITE DATA ANDREWS STORE RD PITTSBORO, NC 27312 PROPERTY ADDRESS CHATHAM COMMUNITY CHURCH INC PROPERTY OWNER STREET 480 HILLSBORO STREET SUITE 800 CITY PITTSBORO, NC 27312 BOBBITT DESIGN BUILD ATTN: BLAIR PITTMAN bpittman@bobbitt.com DESIGNER: EMAIL ADDRESS: PHONE NUMBER: (919) 851-1980 TAX MAP OR PIN NUMBER: 9765 03 41 1385 PARCEL ID NUMBER: 0084062 BOOK 1908 PG 0994 35.82, -79.12 10.50 AC LATITUDE LONGITUDE TOTAL SITE ACREAGE: ACREAGE TO BE DISTURBED: 4.85 AC WATERSHED: POKEBERRY CREEK/HAW RIVER RIVER BASIN: CAPE FEAR RIVER ' EXISTING USE: GENERAL BUILDING USE: BUILDING AREA: PLACE OF WORSHIP ±12,000 SF 60 FEET 22 FEET MAXIMUM BUILDING HEIGHT ALLOWED: MAXIMUM BUILDING HEIGHT PROPOSED: SETBACKS: FRONT: 50' SIDE: REAR: **BUFFERS:** ADJACENT USE/ZONING OPACITY & WIDTH 20' TYPE B STREET 30' TYPE A SIDE USE AREAS: VEHICLE PVMT. AREA: NON-VEHICLE PVMT. AREA: 32,650 SF 4,430 SF 12,000 SF BUILDING AREA TOTAL IMPERVIOUS: 49,080 SF 10.7% % IMPERVIOUS : PARKING: 350 SEAT SANCTUARY (1 SPACE PER 4 SEATS) 88 SPACES TOTAL PROPOSED - (INCLUDES HANDICAP) 91 SPACES HANDICAP SPACES REQUIRED/PROPOSED BOUNDARY AND TOPOGRAPHIC SURVEY BY MAERSTAN PLLC. 1101 PASSPORT WAY, CARY, NORTH CAROLINA 27513. 910.678.5111. DATED: 27 JUNE 2018.

FLOODPLAIN INFORMATION THIS SITE DOES NOT CONTAIN A 100-YR FLOOD PLAIN AREA AS SHOWN ON FIRM PANEL 3710976500K \_\_ DATED \_\_\_\_<u>17\_NOV. 2017</u>\_

INDEX OF SHEETS DESCRIPTION
COVER SHEET
EXISTING CONDITIONS STAKING CONDITIONS
STAKING PLAN
PHASE 1 EROSION CONTROL PLAN
PHASE 2 EROSION CONTROL PLAN
NPDES PLAN
NPDES PLAN C1.0 C2.0 C2.1 C2.2 C2.3 C3.0 C4.0 C5.0 C5.1 C6.0 C7.1 C7.2 C7.3 SD1 SD2 GRADING PLAN
UTILITY PLAN
LANDSCAPE PLAN
LANDSCAPE PLAN — WETLAND LIGHTING PLAN DETAILS DETAILS DETAILS DETAILS ARCHITECTURAL FOOTPRINT ARCHITECTURAL ELEVATIONS

**REVISIONS** APPROVED FOR **PERMITTING NOT FOR CONSTRUCTION** 

CHATHAM COMMUNITY CHURCH

SITE PLAN

think, design, build

COORDINATOR: Blair Pittman

DRAWN BY: Jason Galloway


CHK BY:BPP

24 X 36

PROGRESS

18-0347

COVER

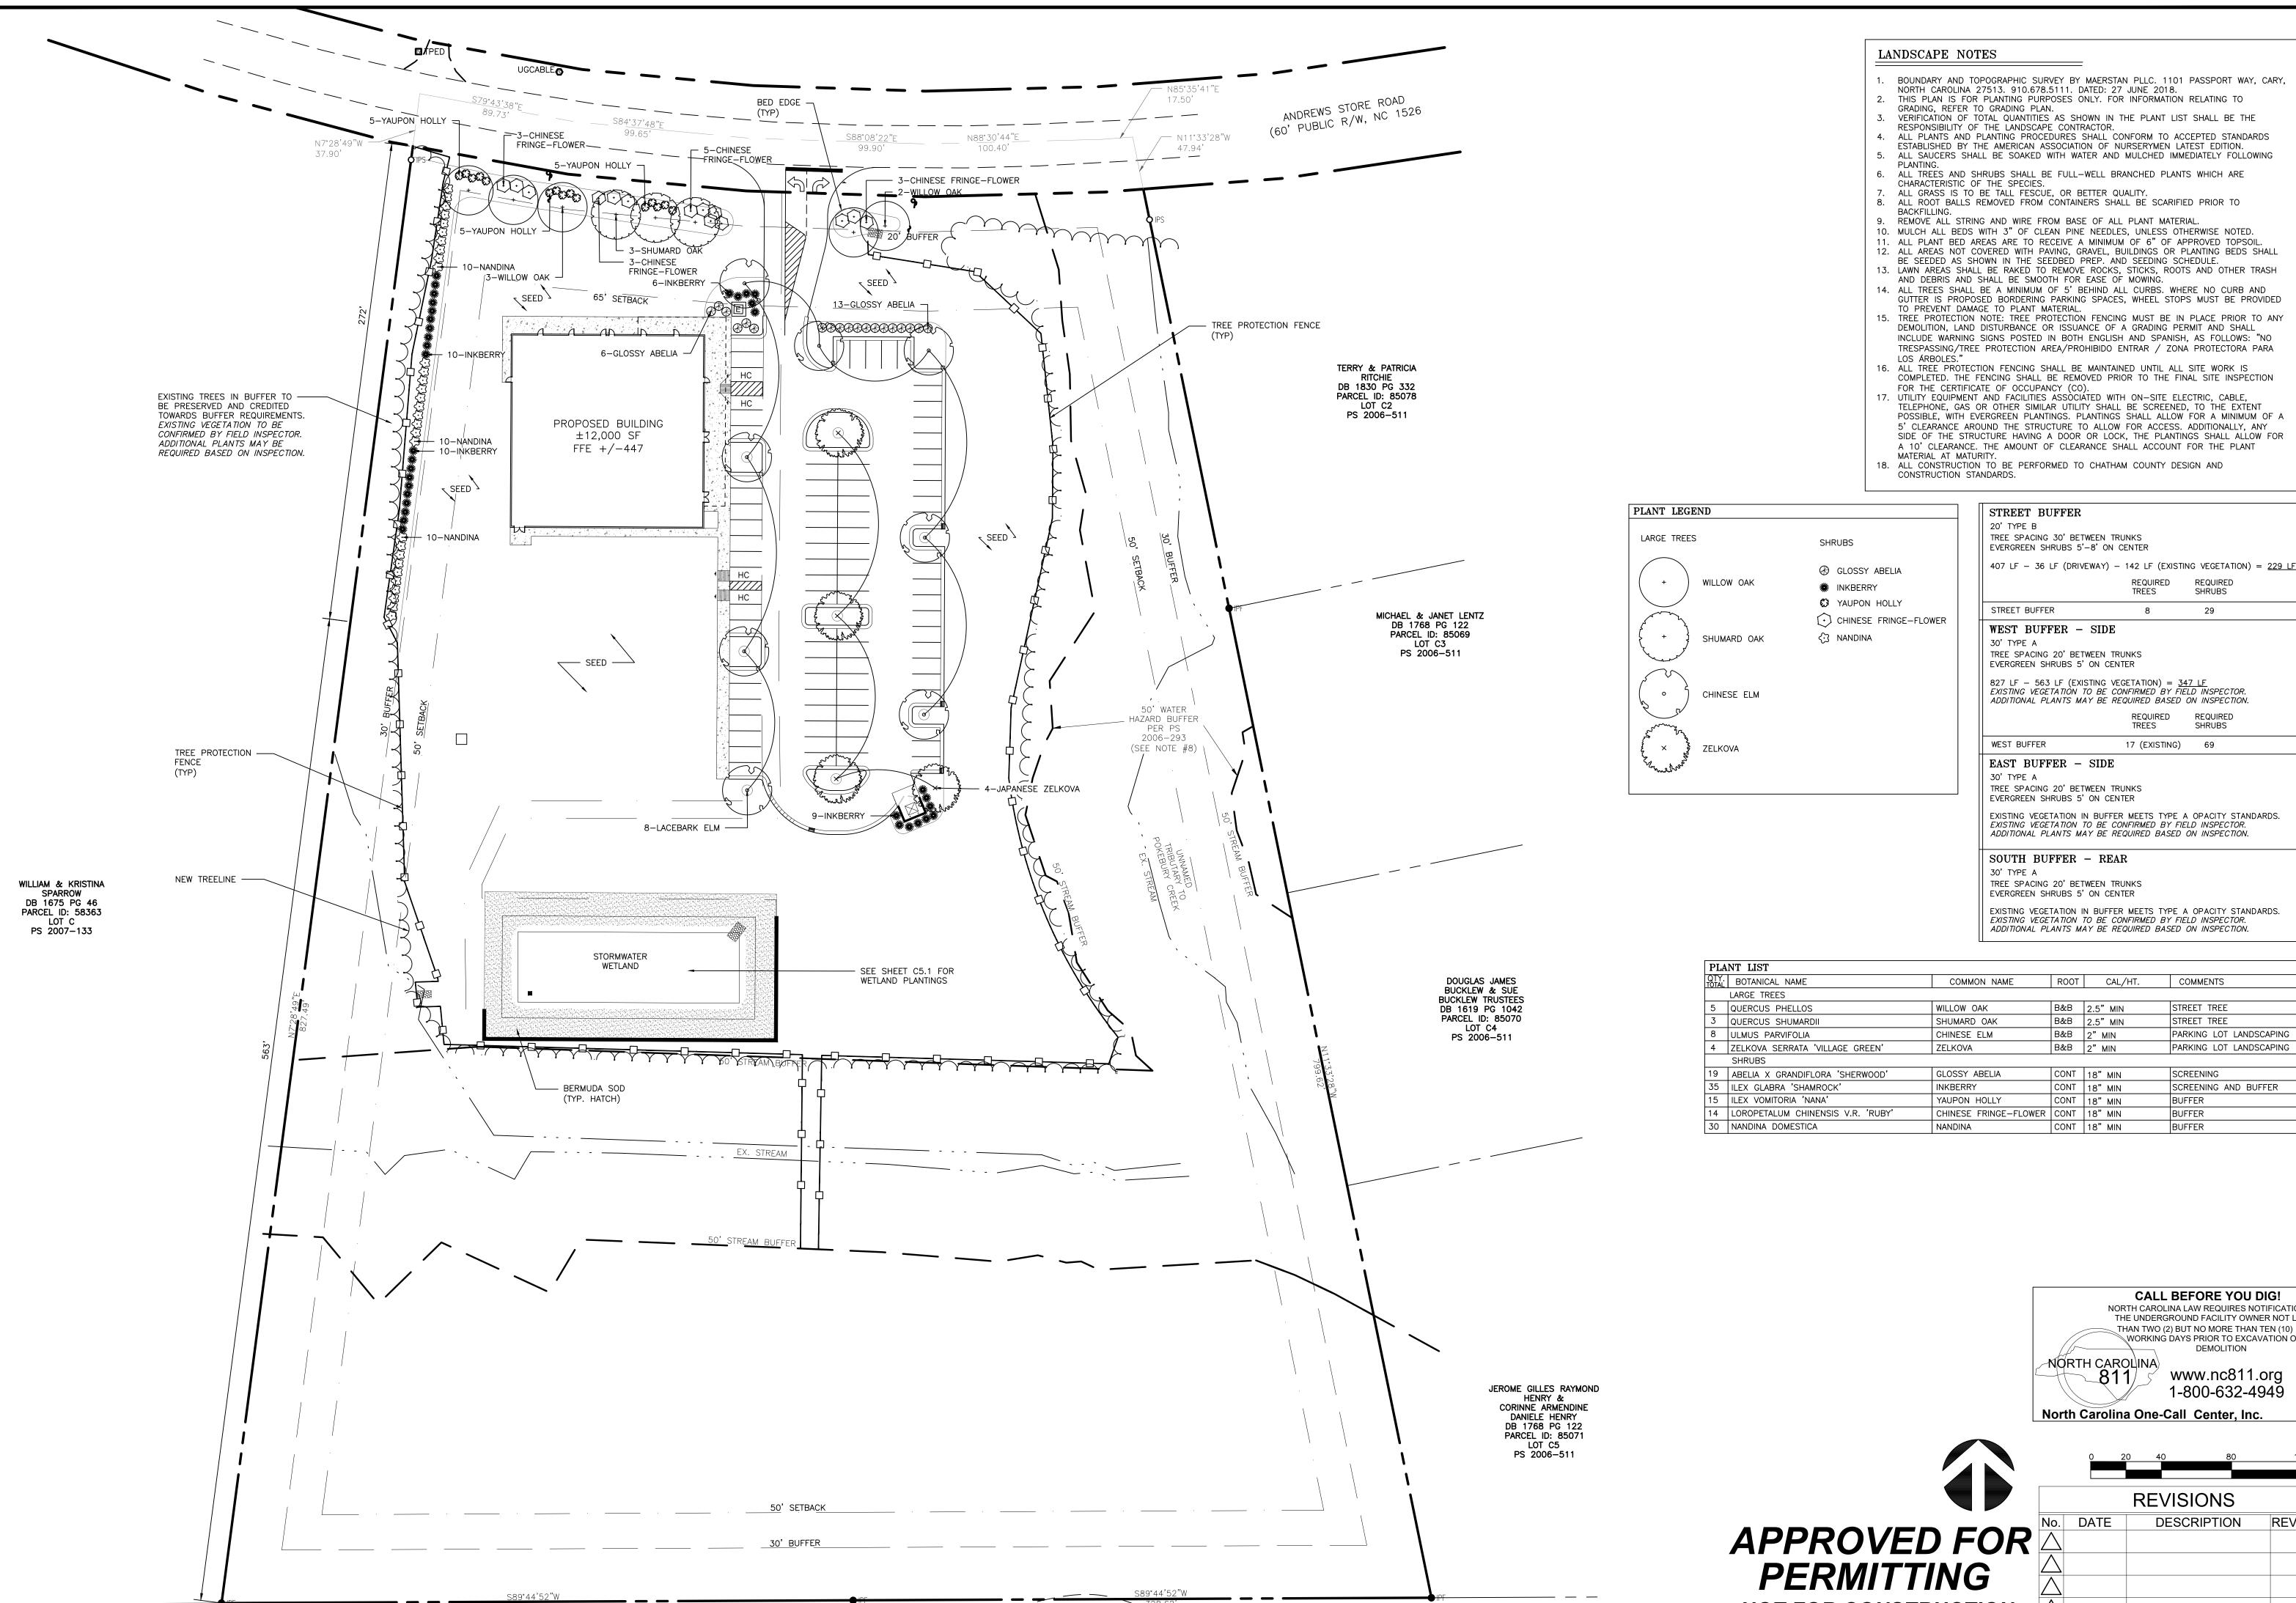

think, design, build

COORDINATOR: Blair Pittman

DRAWN BY: Jason Galloway

CHK BY:BPP

17 (EXISTING) 69

EXISTING VEGETATION IN BUFFER MEETS TYPE A OPACITY STANDARDS. EXISTING VEGETATION TO BE CONFIRMED BY FIELD INSPECTOR.

EXISTING VEGETATION IN BUFFER MEETS TYPE A OPACITY STANDARDS. EXISTING VEGETATION TO BE CONFIRMED BY FIELD INSPECTOR.

| QTY.<br>OTAL | BOTANICAL NAME                    | COMMON NAME           | ROOT | CAL/HT.  | COMMENTS                |
|--------------|-----------------------------------|-----------------------|------|----------|-------------------------|
|              | LARGE TREES                       |                       |      |          |                         |
| 5            | QUERCUS PHELLOS                   | WILLOW OAK            | B&B  | 2.5" MIN | STREET TREE             |
| 3            | QUERCUS SHUMARDII                 | SHUMARD OAK           | B&B  | 2.5" MIN | STREET TREE             |
| 8            | ULMUS PARVIFOLIA                  | CHINESE ELM           | B&B  | 2" MIN   | PARKING LOT LANDSCAPING |
| 4            | ZELKOVA SERRATA 'VILLAGE GREEN'   | ZELKOVA               | B&B  | 2" MIN   | PARKING LOT LANDSCAPING |
|              | SHRUBS                            |                       |      |          |                         |
| 19           | ABELIA X GRANDIFLORA 'SHERWOOD'   | GLOSSY ABELIA         | CONT | 18" MIN  | SCREENING               |
| 35           | ILEX GLABRA 'SHAMROCK'            | INKBERRY              | CONT | 18" MIN  | SCREENING AND BUFFER    |
| 15           | ILEX VOMITORIA 'NANA'             | YAUPON HOLLY          | CONT | 18" MIN  | BUFFER                  |
| 14           | LOROPETALUM CHINENSIS V.R. 'RUBY' | CHINESE FRINGE-FLOWER | CONT | 18" MIN  | BUFFER                  |
| 30           | NANDINA DOMESTICA                 | NANDINA               | CONT | 18" MIN  | BUFFER                  |

**CALL BEFORE YOU DIG!** NORTH CAROLINA LAW REQUIRES NOTIFICATION OF THE UNDERGROUND FACILITY OWNER NOT LESS THAN TWO (2) BUT NO MORE THAN TEN (10) WORKING DAYS PRIOR TO EXCAVATION OR DEMOLITION

North Carolina One-Call Center, Inc.



| 0 2       | 20 4 | 0 8       | 30 | 1   |  |  |  |  |  |
|-----------|------|-----------|----|-----|--|--|--|--|--|
| REVISIONS |      |           |    |     |  |  |  |  |  |
| ATE       |      | ESCRIPTIC | N  | REV |  |  |  |  |  |
|           |      |           |    |     |  |  |  |  |  |
|           |      |           |    |     |  |  |  |  |  |

24 X 36

1" = 40' **PROGRESS** 

18-0347 LANDSCAPE PLAN