RESIDENTIAL SUBDIVISION

- 1. NET AREA IN TRACT: 1,347,871 S.F. (31.495 AC. TO CENTERLINE)
- 2 DRODOSED BOAD: DUI
- 3. PROPOSED ROAD: PUBLIC; PAVED 18' TRAVEL SURFACE; 50' R/W
- 4. WATER SUPPLY: CHATHAM COUNTY PUBLIC WATER.
- 5. SEWAGE DISPOSAL: INDIVIDUAL LOT SEPTIC SYSTEMS
 6. LOT SIZE: 40,018 S.F. TO 118,950 S.F.; AVERAGE = 57,416 S.F.
- 7. PROPOSED SETBACKS: A) MANN'S CHAPEL: 40'; B) INTERIOR FRONT: 40';
- 8. AREA IN PROPOSED PUBLIC STREET RIGHT-OF-WAY: 85,052 S.F.

OTHER INFORMATION

- A. STREAMS: INTERMITTENT AND EPHEMERAL AS SHOWN
- B. WETLANDS: ADJACENT TO STREAM AS SHOWN
- C. FLOODPLAINS: NONE
- D. ADJACENT NATURAL AREAS: NONE
- E. CULTURAL & HISTORICAL RESOURCES: NONE
- F. EXISTING LANDCOVER: HARDWOODS AND PINES EXCEPT AT EXISTING HOUSES
- G. STREAM CROSSING DISTURBANCE: ±114 LF OF EXISTING CHANNEL
- H. WATERSHED: JORDAN LAKE

TRACT INFORMATION

1. PIN: 9766-62-6623; 9766-61-6728

2. AKPAR: 2532; 2533

BONTERRA SUBDIVISION

MAJOR SUBDIVISION CONSTRUCTION DRAWING APPROVAL

3954 MANNS CHAPEL ROAD

CHATHAM COUNTY, NORTH CAROLINA

5/16/2019 **PREPARED FOR**:

NAMED/DEVEL ODER

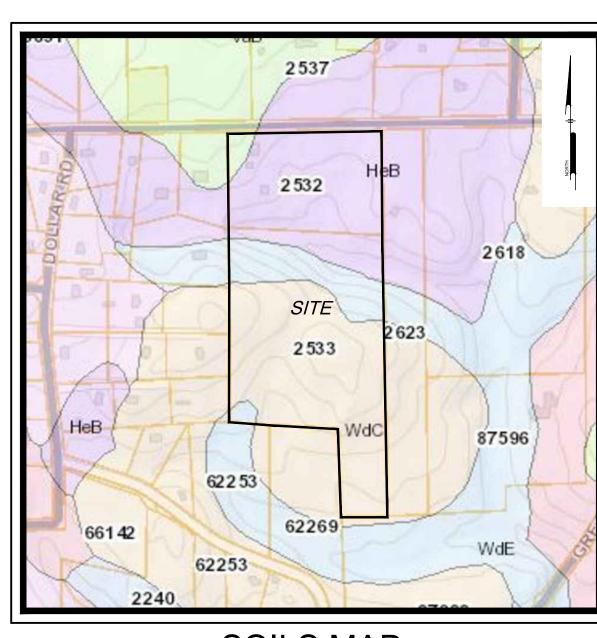
OWNER/DEVELOPER

MANNS CHAPEL DEVELOPMENT LLC


2100 COOK RIDGE COURT

RALEIGH, **NC** 27615

(919) 601-2816



SOILS MAP
Scale: 1" = 500'

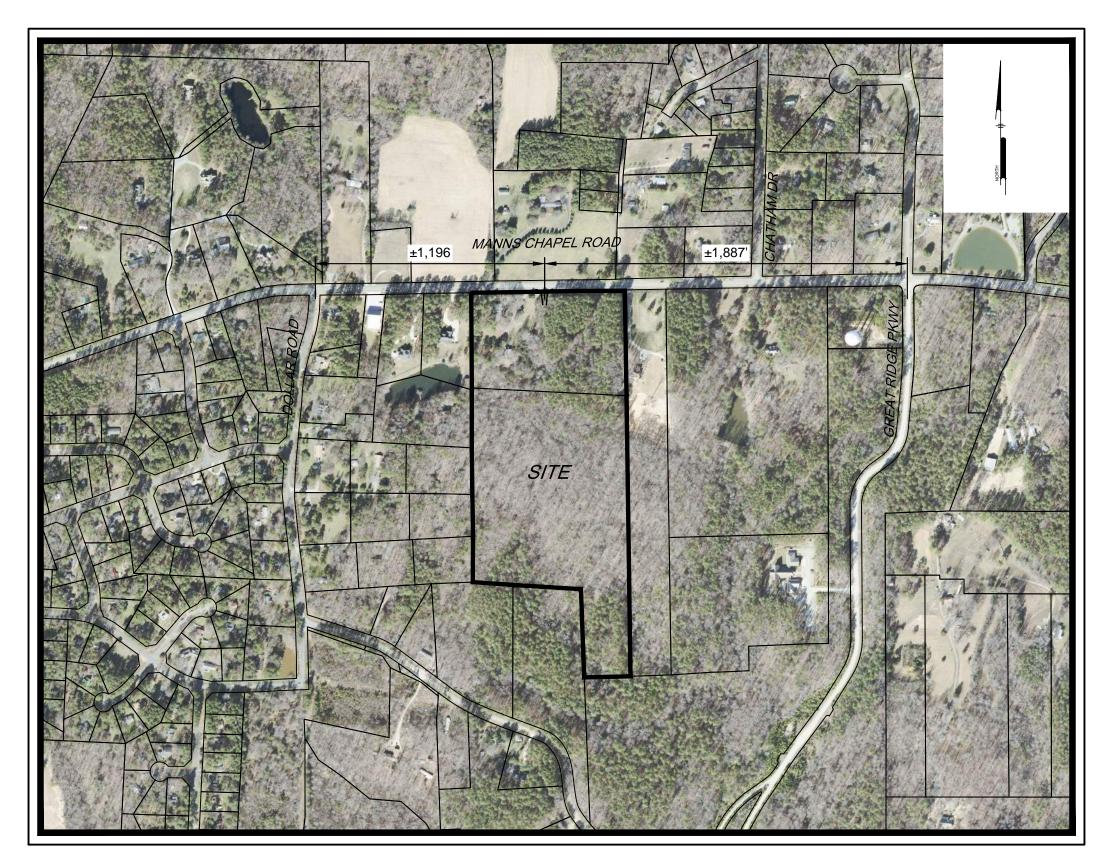

LOCATION MAP

SCALE: 1" = 500'


PREPARED BY:

PENNONI ASSOCIATES INC.



5430 Wade Park Boulevard, #106 Raleigh, NC 27607 **T** 919.929.1173 **F** 919.493.6548

Sheet List Table				
Sheet Name Sheet Number Sheet Title				
CS0001	1	COVER SHEET		
CS0002	2	GENERAL NOTES AND LEGENDS		
CS0201	3	EXISTING CONDITIONS - DEMOLITION PLAN		
CS1001	4	SITE PLAN		
CS1501	5	OVERALL GRADING & UTILITY PLAN (NORTH)		
CS1502	6	OVERALL GRADING & UTILITY PLAN (SOUTH)		
CS1503	7	DETAILED GRADING & UTILITY PLAN		
CS1504	8	BONTERRA WAY PROFILE (NORTH)		
CS1505	9	BONTERRA WAY PROFILE (SOUTH)		
CS6001	10	SITE DETAILS		
CS6041	11	WATER DETAILS		
CS8001	12	EROSION CONTROL PLAN (NORTH)-PHASE I		
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CS8501	16	EROSION CONTROL DETAILS		
CS8502	17	EROSION CONTROL DETAILS		
CS8503	18	EROSION CONTROL DETAILS		
CS9001	19	DRY-DETENTION POND DETAILS		

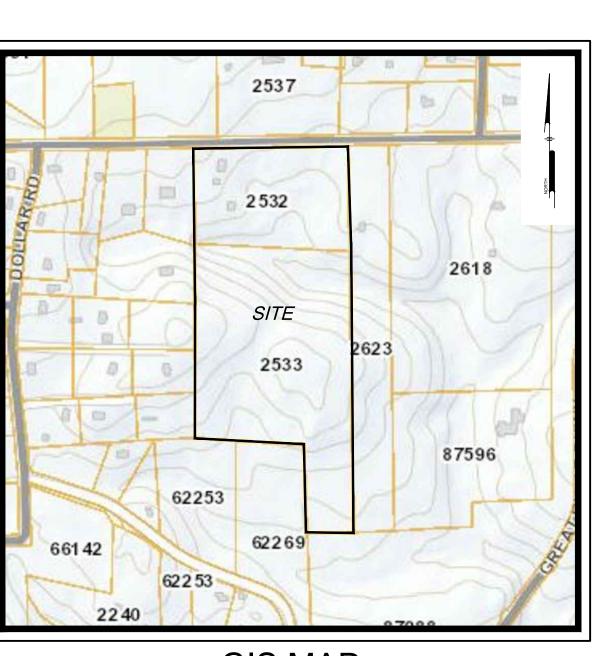


GIS MAP Scale: 1" = 500'

Know what's below.

Call before you dig.

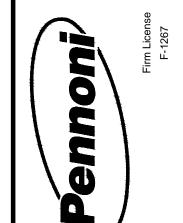Electronic copy received by Division 8/District 1 office 05/23/2019



PENNONI ASSOCIATES
5430 Wade Park Boulevard,
Raleigh, NC 27607

LL DIMENSIONS MUST BE VERIFIED BY CONTRACTO
AND OWNER MUST BE NOTIFIED OF ANY
DISCREPANCIES BEFORE PROCEEDING WITH WORK

CARONIC SERVICE

STATISTICS

633040

ER SHEET

MANNS CHAPEL DEVELOP

2019	9	PER CHATHAM COUNTY SW & EC	CJJ	
2019	2	PER CHATHAM COUNTY SW & EC	CJJ	
2019	4	PER CHATHAM COUNTY SW & EC	CSB	
2019	8	REV. PER NCDOT COMMENTS	CSB	
2019	2	REV. PER NCDOT COMMENTS	CSB	
/2018	1	NCDOT SUBMITTAL	AAA	
TE	NO.	REVISIONS	ВҮ	

ALL DOCUMENTS PREPARED BY PENNONI ASSOCIATE ARE INSTRUMENTS OF SERVICE IN RESPECT OF THE PROJECT. THEY ARE NOT INTENDED OR REPRESENT TO BE SUITABLE FOR REUSE BY OWNER OR OTHERS OF THE EXTENSIONS OF THE PROJECT OR ON ANY OTHE PROJECT. ANY REUSE WITHOUT WRITTEN VERIFICATION OR ADAPTATION BY PENNONI ASSOCIATE FOR THE SPECIFIC PURPOSE INTENDED WILL BE AT OWNERS SOLE RISK AND WITHOUT LIABILITY OR LEGAL EXPOSURE TO PENNONI ASSOCIATE; AND OWNER SHA INDEMNIFY AND HOLD HARMLESS PENNONI ASSOCIATE FROM ALL CLAIMS, DAMAGES, LOSSES AND EXPENSE ARISING OUT OF OR RESULTING THEREFROM.

ROJECT	DLAZ1701
)ATE	10/11/2018
PRAWING SCALE	NTS
DRAWN BY	AAA
PPROVED BY	РСВ

CS0001

EXISTING	LEGEND PROPOSED	DESCRIPTION	<u>(</u>	GENERAL NOTES:	
TIE THE	ma	CABLE TV, JUNCTION BOX		 APPLICANT: MANNS CHAPEL DEVELOPM 	RESPONSIBLE OFFICER: DAVID LAZZO
		CABLE TV, MANHOLE		2100 COOK RIDGE COURT RALEIGH, NC 27615	
	oc oc	CABLE TV, OVERHEAD CABLE TV, PANEL BOX			
M W	11	CABLE TV, PAIVEL BOX CABLE TV, PEDESTAL	:		EATURES WERE OBTAINED FROM A TOPOGRAPHIC SUR\ ASSOCIATES ON OR ABOUT 9/21/2017
₩	₩	CABLE TV, STUB OUT			
		CABLE TV, UNDERGROUND CABLE TV, WITNESS POST	:		RACY OF LOCATION AND DEPTH OF UNDERGROUND UTI
	-o- 	CHANNEL			NG AND PROPOSED SERVICES ARE APPROXIMATE AND
		COMMUNICATION, HANDHOLE		COMMENCEMENT OF AN	PENDENTLY WITH LOCAL UTILITY COMPANIES PRIONY CONSTRUCTION OR EXCAVATION. SANITARY SEWEI
	 (C)	COMMUNICATION, JUNCTION BOX COMMUNICATION, MANHOLE		INDEPENDENTLY BY	SERVICE CONNECTION POINTS SHALL BE CONFITHE CONTRACTOR IN THE FIELD PRIOR TO
oc	oc oc	COMMUNICATION, OVERHEAD			CONSTRUCTION. ALL DISCREPANCIES SHALL BE REPONDED TO THE ENGINEER. CONSTRUCTION SHALL COMM
<u> </u>	23	COMMUNICATION, PANEL BOX		GRADIENT. PROPOSEI	WEST INVERT (POINT OF CONNECTION) AND PROGRE D INTERFACE POINTS (CROSSINGS) WITH EXI
© m	© #8	COMMUNICATION, PEDESTAL COMMUNICATION, STUB OUT		UNDERGROUND UTILITIC COMMENCEMENT OF CO	IES SHALL BE FIELD VERIFIED BY TEST PIT PRIC DNSTRUCTION.
—— uc —— uc —	— uc —— uc —	COMMUNICATION, STOR COT COMMUNICATION, UNDERGROUND			ICES INCLUDING BUT NOT LIMITED TO GAS, WATER, ID STORM SEWER, TELEPHONE, CABLE, FIBER OPTIC, ET
-o- -		COMMUNICATION, WITNESS POST			ISTURBANCE SHALL BE VERTICALLY AND HORIZONTALL CTOR SHALL USE AND COMPLY WITH THE REQUIREMEN
Φ.		CONTROL, BENCHMARK CONTROL, GPS			Y NOTIFICATION SYSTEM TO LOCATE ALL THE UNDERGE CTOR IS RESPONSIBLE FOR REPAIRS OF DAMAGE TO AN
<u> </u>		CONTROL, MAPPING		EXISTING UTILITIES DUR	ING CONSTRUCTION AT NO COST TO THE OWNER.
Δ		CONTROL, REFERENCE	•		INSURANCE RATE MAP FOR ORANGE COUNTY, NC, MAF J), EFFECTIVE DATE 11/17/17 THE SITE AREA PROPOSE
Δ		CONTROL, TRAVERSE CURB		BE DEVELOPED LIES WITHII THE 100 YEAR FLOOD PLAIN	N "ZONE X" DEFINED AS AREAS DETERMINED TO BE OU ⁻ N.
		CURB DEPRESSION			
		EDGE OF PAVEMENT			
		EDGE OF GRAVEL			
		EASEMENT			
		FENCE			
<u> </u>	×	FIBER OPTIC, HANDHOLE			
		FIBER OPTIC, JUNCTION BOX FIBER OPTIC, MANHOLE			
	F0 F0	FIBER OPTIC, OVERHEAD			
		FIBER OPTIC, PANEL BOX			
(FO)	FO 80	FIBER OPTIC, PEDESTAL FIBER OPTIC, STUB OUT			
	— FO —— FO ——	FIBER OPTIC, UNDERGROUND			
-0-	-0-	FIBER OPTIC, WITNESS POST			
F)	(FL)	FLOODPLAIN FUEL, MANHOLE			
OFG	— OFG — OFG —	FUEL, OVERHEAD			
ew; Punp	€©¢ PUMPI	FUEL, PLUG FUEL, PUMP			
—— UFG —— UFG ——	UFG UFG	FUEL, UNDERGROUND			
<u> </u>	i i i	GUIDE RAIL			
<u> </u>	— LOD ——— ჭ	— LIMITS OF DISTURBANCE MARKING, HANDICAP PARKING			
		NATURAL GAS, METER			
G	<u>(C)</u>	NATURAL GAS, MANHOLE		LECEND	
	og og	NATURAL GAS, OVERHEAD NATURAL GAS, STUB OUT	EXISTING	LEGEND PROPOSED	DESCRIPTION
[(COL)	NATURAL GAS, WANDERGROUND	0	O	SANITARY SEWER, CLEAN-OUT
UG	UG UG	NATURAL GAS, WITNESS POST		- — ғм — - ғм —	_ SANITARY SEWER, FORCE MAIN
——————————————————————————————————————	— —	PHONE, HANDHOLE PHONE, JUNCTION BOX	FM	(FM)	SANITARY SEWER, FORCE MAIN MANHOLE SANITARY SEWER, FORCE STUB OUT
Ţ.B	ŢÆ	PHONE, MANHOLE	s s s	- 	SANITARY SEWER, LATERAL
T		PHONE, OVERHEAD	(\$)	<u>S</u>	SANITARY SEWER, MANHOLE
	от от	PHONE, PANEL BOX PHONE, PEDESTAL	s s	s — s —	SANITARY SEWER, UNDERGROUND (4" DIA TO 10" DIA SANITARY SEWER, SEPTIC TANK
	<u> </u>	PHONE, STUB OUT	₩	▽	SANITARY SEWER, STUB OUT
₩	♥	PHONE, UNDERGROUND			SANITARY SEWER, VALVE
UTUT	—— UT ——— UT —— ⊕-	PHONE, WITNESS POST POWER, GUY POLE	-0-	-0-	SANITARY SEWER, WITNESS POST STREAM
	(—	POWER, GUY WIRE			STORM SEWER, INLET
		POWER, HANDHOLE		L	STORM SEWER, HEADWALL
	<u></u>	POWER, JUNCTION BOX POWER, SINGLE HEAD LIGHT		_	STORM SEWER, MANHOLE STORM SEWER, UNDERGROUND
	略	POWER, DOUBLE HEAD LIGHT	υ — υ —	*	STORM SEWER, DOWNSPOUT LOCATION
CO CO	ζ ά ζ	POWER, THREE HEAD LIGHT	D	— RD —— RD —— RD —	STORM SEWER, ROOF DRAIN LINE
		POWER, FOUR HEAD LIGHT	0	O	STORM SEWER, STAND PIPE STORM SEWER, CLEAN-OUT
\$	$\bar{\nabla}$	POWER, LIGHT POWER, SPOTLIGHT	-0-	y - - -	STORM SEWER, WITNESS POST
₹	₹ ○ □	POWER, SPOTLIGHT POWER, LIGHT POLE SINGLE		101	_ MINOR CONTOUR
		POWER, LIGHT POLE DOUBLE		100-100.5	MAJOR CONTOUR SPOT ELEVATION
(<u>L</u>)	(E)	POWER, MANHOLE POWER, OVERHEAD	Λ	T.B.R.	TO BE REMOVED
OE OE	① OE — OE —	POWER, METER	o ko	oĥo	TRAFFIC, PAVEMENT MARKING, BIKE LANE
EPB	EPB .	POWER, PANEL BOX	会会会企会	会会会会	
(E)	E T	POWER, PEDESTAL POWER, STUB OUT	.п. пПп,	.п. пПп,	TRAFFIC, PAVEMENT MARKING, TURN ARROWS
7	Ţ Z	POWER, TRANSFORMER	会的公司的		
UE	— Е — — Е —	— POWER, UNDERGROUND	, Л , , , Л П , ,	ν .Λ. ⊿∏ Γ.	
Q	Ø	POWER, UTILITY POLE POWER, WITNESS POST	\Q	\Diamond	TRAFFIC, PAVEMENT MARKING, HOV LANE TRAFFIC, HAND HOLE
-□- ☆		POWER, WITNESS POST POWER, YARD LIGHT		<u></u>	TRAFFIC, JUNCTION BOX
	715	PROPERTY, LINE		<u>(10)</u>	TRAFFIC, MANHOLE
		LEGAL RIGHT-OF-WAY PROPERTY, CORNER FOUND	M	™	TRAFFIC, PANEL BOX TRAFFIC, PEDESTAL
○	● �	PROPERTY, CORNER FOUND (OTHERS)		- -	TRAFFIC, PEDESTRIAN SIGNAL
•	•	PROPERTY, CONCRETE MONUMENT		- - - - -	TRAFFIC, SIGNAL POLE
		PROPERTY, ADJOINING LINED PROPERTY LINE RESERVED		\bigcirc	TRAFFIC, SIGNAL POLE & LIGHT ARM TRAFFIC, STUB OUT
• • • • • • • • • • • • • • • • • • •	©	PROPERTY, LINE RESERVED RAIL, MILE MARKER	® ⇔	₩	VEGETATION, SHRUB
REPE	RRPB	RAIL, PANEL BOX	~~~~~~~~~~~~~~~~~~~~~~~~~~~~~~~~~~~~~~	-	VEGETATION, GRASS LINE / LANDSCAPED AREA
	_	RAIL, TRACK	(Cod)		VEGETATION, DECIDUOUS SHOWING CANOPY
ALC AC	W	SITE, AIR COMPRESSOR SITE, AIR CONDITIONER			VEGETATION, CONIFEROUS SHOWING CANOPY VEGETATION, TREE LINE
0	0	SITE, AIR CONDITIONER SITE, BOLLARD			WATER, HOSE BIB
•	<u> </u>	SITE, BORING LOCATION	- Ó -	.	WATER, FIRE HYDRANT
	(BUILDING SITE, FLAG POLE	⊕ ⊠	⊚ ⊠	WATER, IRRIGATION HEAD WATER, IRRIGATION VALVE BOX
9 @	9 2	SITE, HEAD STONE	₩	⊠ (₩)	WATER, MANHOLE
□	⊠	SITE, MAIL BOX	0		WATER, METER
⊚	⊕	SITE, MONITOR WELL SITE PARKING METER			WATER, POST INDICATOR VALVE WATER, SIAMESE CONNECTION
⊕	♥ ⊕	SITE, PARKING METER SITE, POST		幽 天	WATER, STUB OUT
- 0 0	- 0 0	SITE, SIGN POST AND BOARD	ww	- w w	WATER, UNDERGROUND
0	- 0-	SITE, TRAFFIC SIGN	FF	- F	_ WATER, UNDERGROUND FIRE
		SOIL BOUNDARY		\otimes	WATER, VALVE

GENERAL CONSTRUCTION AND GRADING NOTES:

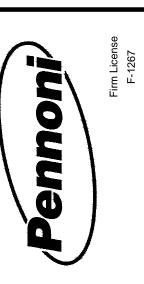
- 1. ALL WORK SHALL COMPLY WITH APPLICABLE STATE, FEDERAL AND LOCAL CODES AND OSHA STANDARDS ALL NECESSARY LICENSES AND PERMITS SHALL BE OBTAINED BY THE CONTRACTOR AT HIS EXPENSE UNLESS PREVIOUSLY OBTAINED BY THE OWNER/DEVELOPER.
- 2. THE CONTRACTOR SHALL BE REQUIRED TO REVIEW AND ABIDE BY SPECIFICATIONS OF THE PLAN AND ALL SUPPORTING DOCUMENTS, PERMITS, AND REPORTS FOR THIS SITE, INCLUDING NOT BUT NOT LIMITED TO: EROSION AND SEDIMENTATION CONTROL PLAN
- 3. THE CONTRACTOR SHALL IMMEDIATELY INFORM THE ENGINEER OF ANY DISCREPANCIES OR ERROR THEY DISCOVER IN THE PLANS.

STORMWATER MANAGEMENT PLAN.

- 4. DEVIATION FROM THESE PLANS AND NOTES WITHOUT THE PRIOR CONSENT OF THE OWNER OR HIS REPRESENTATIVE OR THE ENGINEER MAY BE CAUSE OF THE WORK TO
- 5. UTILITY COORDINATION SHALL BE INCLUDED IN THE PROJECT SCHEDULE AND IT IS THE EXPLICIT RESPONSIBILITY OF THE CONTRACTOR TO ASSURE THAT THE PROJECT SCHEDULE INCLUDES THE NECESSARY RELOCATIONS. THE CONTRACTOR WILL NOT BE PAID ADDITIONALLY FOR THIS COORDINATION. THE CONTRACTOR SHOULD SEEK ASSISTANCE FROM ALL UTILITY COMPANIES TO LOCATE AND PROTECT THEIR FACILITIES. IF CONFLICTS ARE FOUND, THE CONTRACTOR SHALL IMMEDIATELY NOTIFY THE OWNER AND DESIGN ENGINEER FOR INSTRUCTION BEFORE PROCEEDING WITH
- 6. ALL MATERIALS SHALL BE NEW UNLESS USED OR SALVAGED MATERIALS ARE AUTHORIZED BY THE OWNER AND APPLICANT.
- 7. TRAFFIC CONTROL METHODS, SUCH AS BARRICADES, SUFFICIENT LIGHTS, SIGNS, ETC., MAY BE NECESSARY FOR THE PROTECTION AND SAFETY OF THE PUBLIC SHALL BE PROVIDED AND MAINTAINED THROUGHOUT THE CONSTRUCTION IN ACCORDANCE WITH
- 8. CONTRACTOR SHALL FURNISH AND MAINTAIN ALL NECESSARY BARRICADES, FENCING AND OTHER APPROPRIATE SAFETY ITEMS/MEASURES NECESSARY TO PROTECT THE PUBLIC FROM THE WORK AREA CONSTRUCTION ACTIVITIES.
- 9. HIGH INTENSITY LIGHTING FACILITIES SHALL BE SO ARRANGED THAT THE SOURCE OF ANY LIGHT IS CONCEALED FROM PUBLIC VIEW AND FROM ADJACENT RESIDENTIAL PROPERTY AND DOES NOT INTERFERE WITH TRAFFIC.
- 10. THE CONTRACTOR SHALL MAINTAIN ACCESS FOR EMERGENCY VEHICLES AROUND AND TO ALL BUILDINGS NEAR CONSTRUCTION. IN TIME OF RAIN OR MUD, ROADS SHALL BE ABLE TO CARRY A FIRE TRUCK BY BEING PAVED OR HAVING A CRUSHED STONE BASE ETC., WITH A MINIMUM WIDTH OF 20 FEET. ACCESS TO BUILDINGS THAT HAVE SPRINKLER OR STANDPIPE SYSTEMS SHALL BE WITHIN 40 FEET OF THE FIRE DEPARTMENT CONNECTOR. (NFPA 1141 3-1)
- 11. BEDDING REQUIREMENTS SPECIFIED HEREIN ARE TO BE CONSIDERED AS MINIMUMS FOR RELATIVELY DRY, STABLE EARTH CONDITIONS. ADDITIONALLY BEDDING SHALL BE REQUIRED FOR ROCK TRENCHES AND WET AREAS. CONTRACTOR SHALL HAVE THE RESPONSIBILITY TO PROVIDE SUCH ADDITIONAL BEDDING AS MAY BE REQUIRED TO PROPERLY CONSTRUCT THE WORK.
- 12. BACKFILL OF ALL TRENCHES SHALL BE COMPACTED TO THE DENSITY OF 95% OF THEORETICAL MAXIMUM DRY DENSITY (ASTM D698). BACKFILL MATERIAL SHALL BE FREE FROM ROOTS, STUMPS, OR OTHER FOREIGN DEBRIS AND SHALL BE PLACED IN LAYERS NOT TO EXCEED SIX (6) INCHES IN COMPACTED FILL THICKNESS. A REPORT FROM A GEOTECHNICAL ENGINEER MAY BE REQUIRED BY THE PUBLIC WORKS INSPECTOR. CORRECTION OF ANY TRENCH SETTLEMENT WITHIN A YEAR FROM THE DATE OF APPROVAL WILL BE THE RESPONSIBILITY OF THE CONTRACTOR.
- 13. THE CONTRACTOR WILL ENSURE THAT POSITIVE AND ADEQUATE DRAINAGE IS MAINTAINED AT ALL TIMES WITHIN THE PROJECT LIMITS. THIS MAY INCLUDE, BUT NOT BE LIMITED TO, A) REPLACEMENT OR RECONSTRUCTION OF EXISTING DRAINAGE STRUCTURES THAT HAVE BEEN DAMAGED OR REMOVED, OR B) REGRADING AS REQUIRED BY THE ENGINEER, EXCEPT FOR THOSE DRAINAGE ITEMS SHOWN AT SPECIFIC LOCATIONS AND HAVING SPECIFIC PAY ITEMS IN THE DETAILED ESTIMATE. NO SEPARATE PAYMENT WILL BE MADE FOR ANY COSTS INCURRED TO COMPLY WITH THIS
- 14. THE CONTRACTOR SHALL PROVIDE ANY AND ALL EXCAVATION AND MATERIAL SAMPLES NECESSARY TO CONDUCT REQUIRED SOIL TESTS. ALL ARRANGEMENTS AND SCHEDULING FOR THE TESTING SHALL BE THE CONTRACTOR'S RESPONSIBILITY.
- 15. SOIL TESTING AND ON-SITE INSPECTION SHALL BE PERFORMED BY AN INDEPENDENT GEOTECHNICAL ENGINEER. A GEOTECHNICAL ENGINEER IS REQUIRED TO INSPECT, TEST AND CERTIFY TO THE COMPACTION OF ALL LOAD BEARING FILLS. THE GEOTECHNICAL ENGINEER SHALL PROVIDE COPIES OF TEST REPORTS TO THE CONTRACTOR, THE OWNER AND TO THE OWNER'S REPRESENTATIVE AND SHALL PROMPTLY NOTIFY THE OWNER, HIS REPRESENTATIVE AND THE CONTRACTOR, SHOULD WORK PERFORMED BY THE CONTRACTOR FAIL TO MEET THESE SPECIFICATIONS.
- 16. ALL PERMITS MUST BE OBTAINED PRIOR TO THE START OF CONSTRUCTION
- 17. ALL PAVEMENT MARKINGS AND REGULATORY SIGNS SHALL CONFORM TO CURRENT MUTCD STANDARDS.
- 18. ALL ROADWAY CONSTRUCTION SHALL BE IN ACCORDANCE WITH CURRENT NCDOT STANDARDS AND SPECIFICATIONS.

GENERAL UTILITY NOTES:


- 1. ALL UTILITIES AND SERVICES INCLUDING BUT NOT LIMITED TO GAS, WATER, ELECTRIC, SANITARY AND STORM SEWER, TELEPHONE, CABLE, FIBER OPTIC, ETC. WITHIN THE LIMITS OF DISTURBANCE SHALL BE VERTICALLY AND HORIZONTALLY LOCATED. THE CONTRACTOR SHALL USE AND COMPLY WITH THE REQUIREMENTS OF THE APPLICABLE UTILITY NOTIFICATION SYSTEM TO LOCATE ALL THE UNDERGROUND UTILITIES. THE CONTRACTOR IS RESPONSIBLE FOR REPAIRS OF DAMAGE TO ANY EXISTING UTILITIES DURING CONSTRUCTION AT NO COST TO THE OWNER.
- 2. UTILITY COORDINATION SHALL BE INCLUDED IN THE PROJECT SCHEDULE AND IT IS THE EXPLICIT RESPONSIBILITY OF THE CONTRACTOR TO ASSURE THAT THE PROJECT SCHEDULE INCLUDES THE NECESSARY RELOCATIONS. THE CONTRACTOR WILL NOT BE PAID ADDITIONALLY FOR THIS COORDINATION.
- 3. IT IS THE RESPONSIBILITY OF THE CONTRACTOR TO DETERMINE THE LOCATIONS AND DEPTHS OF ALL EXISTING UNDERGROUND UTILITIES AND STRUCTURES BEFORE THE START OF WORK AND TO TAKE WHATEVER STEPS NECESSARY TO PROVIDE FOR THEIR PROTECTION. THE ENGINEER HAS DILIGENTLY ATTEMPTED TO LOCATE AND INDICATE ALL EXISTING FACILITIES ON THESE PLANS; HOWEVER, THIS INFORMATION IS SHOWN FOR THE CONTRACTOR'S CONVENIENCE ONLY. THE ENGINEER ASSUMES NO RESPONSIBILITY FOR THE LOCATIONS OF UTILITIES SHOWN OR NOT SHOWN. COMPLETENESS OR ACCURACY OF LOCATION AND DEPTH OF UNDERGROUND UTILITIES AND STRUCTURES IS NOT GUARANTEED.
- THE CONTRACTOR SHALL CONTACT ALL UTILITY COMPANIES FOR EXACT LOCATION AND PROTECTION OF THEIR UTILITIES PRIOR TO STARTING CONSTRUCTION. IT SHALL BE THE SOLE RESPONSIBILITY OF THE CONTRACTOR TO REPAIR AND REPLACE ANY AND ALL DAMAGE MADE TO UTILITIES BY THE CONTRACTOR.
- CONTRACTOR MUST APPLY FOR ALL UTILITY CONNECTION APPLICATIONS. CONTRACTOR IS RESPONSIBLE FOR ALL UTILITY CONNECTION FEES FOR CONSTRUCTION. REFER TO COVER SHEET FOR AVAILABLE UTILITY COMPANY LIST.
- 6. CONTRACTOR MUST OBTAIN ANY REQUIRED UTILITY DETAILS FOR RECONNECTION OF EXISTING SERVICES OR NEW SERVICE AND IS RESPONSIBLE FOR THE CONSTRUCTION OF EACH NEW SERVICE PER THE APPROPRIATE UTILITY COMPANY'S SPECIFICATIONS.
- 7. THE CONTRACTOR SHALL COORDINATE LOCATION AND INSTALLATION OF ALL UNDERGROUND UTILITIES AND APPURTENANCES TO MINIMIZE DISTURBANCE TO CURBING, PAVING, AND COMPACTED SUB-GRADE.
- 8. IF CONFLICTS ARE FOUND, THE CONTRACTOR SHALL IMMEDIATELY NOTIFY THE OWNER AND ENGINEER FOR INSTRUCTION BEFORE PROCEEDING WITH WORK.
- 9. ALL PIPE LENGTHS AND DISTANCES BETWEEN STRUCTURES ARE MEASURED FROM CENTER OF STRUCTURE TO CENTER OF STRUCTURE ALONG A HORIZONTAL PLANE.
- 10. THE CONTRACTOR SHALL PROVIDE ANY AND ALL EXCAVATION AND MATERIAL SAMPLES NECESSARY TO CONDUCT REQUIRED SOIL TESTS. ALL ARRANGEMENTS AND SCHEDULING FOR THE TESTING SHALL BE THE CONTRACTOR'S RESPONSIBILITY.
- 11. SOILS TESTING AND ON-SITE INSPECTION SHALL BE PERFORMED BY AN INDEPENDENT GEOTECHNICAL ENGINEER. THE SOILS ENGINEER SHALL PROVIDE COPIES OF TEST REPORTS TO THE CONTRACTOR, THE OWNER AND THE OWNER'S REPRESENTATIVE AND SHALL PROMPTLY NOTIFY THE OWNER, HIS REPRESENTATIVE AND THE CONTRACTOR SHOULD WORK PERFORMED BY THE CONTRACTOR FAIL TO MEET THESE SPECIFICATIONS.
- 12. CONTRACTOR SHALL EXCAVATE ONLY ENOUGH TRENCH FOR WHICH PIPE CAN BE INSTALLED AND TRENCH BACKFILLED BY THE END OF EACH WORK DAY.
- 13. BEDDING REQUIREMENTS SPECIFIED HEREIN ARE TO BE CONSIDERED AS MINIMUMS FOR RELATIVELY DRY, STABLE EARTH CONDITIONS. ADDITIONAL BEDDING SHALL BE REQUIRED FOR ROCK TRENCHES AND WET AREAS. CONTRACTOR SHALL HAVE THE RESPONSIBILITY TO PROVIDE SUCH ADDITIONAL BEDDING AS MAY BE REQUIRED TO PROPERLY CONSTRUCT THE WORK.
- 14. COMPACTION OF THE BACKFILL OF ALL TRENCHES SHALL BE COMPACTED TO THE DENSITY OF 95% OF THEORETICAL MAXIMUM DRY DENSITY (ASTM D698). BACKFILL MATERIAL SHALL BE FREE FROM ROOTS, STUMPS, OR OTHER FOREIGN DEBRIS AND SHALL BE PLACED IN LIFTS NOT TO EXCEED 6 INCHES IN COMPACTED FILL THICKNESS. A REPORT FROM A GEOTECHNICAL ENGINEER MAY BE REQUIRED BY THE PUBLIC WORKS INSPECTOR. CORRECTION OF ANY TRENCH SETTLEMENT WITHIN A YEAR FROM THE DATE OF APPROVAL WILL BE THE RESPONSIBILITY OF THE CONTRACTOR.
- 15. RUNOFF FROM IMPERVIOUS AREAS SHALL NOT BE DIRECTED INTO THE SANITARY SEWER NOR ONTO ADJACENT PROPERTIES.
- 16. ALL JOINTS ON THE STORM WATER CONVEYANCE SYSTEM SHALL BE WATERTIGHT.
- 17. ALL CONSTRUCTION ASSOCIATED WITH WATER SHALL BE IN ACCORDANCE WITH CHATHAM COUNTY PUBLIC WORKS STANDARDS AND SPECIFICATIONS.
- 18. ALL ELECTRICAL SERVICE LINES TO OR AROUND THE PROPOSED STRUCTURE SHALL BE UNDERGROUND.




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PROJECT DLAZ1701 10/11/2018 DRAWING SCALE DRAWN BY



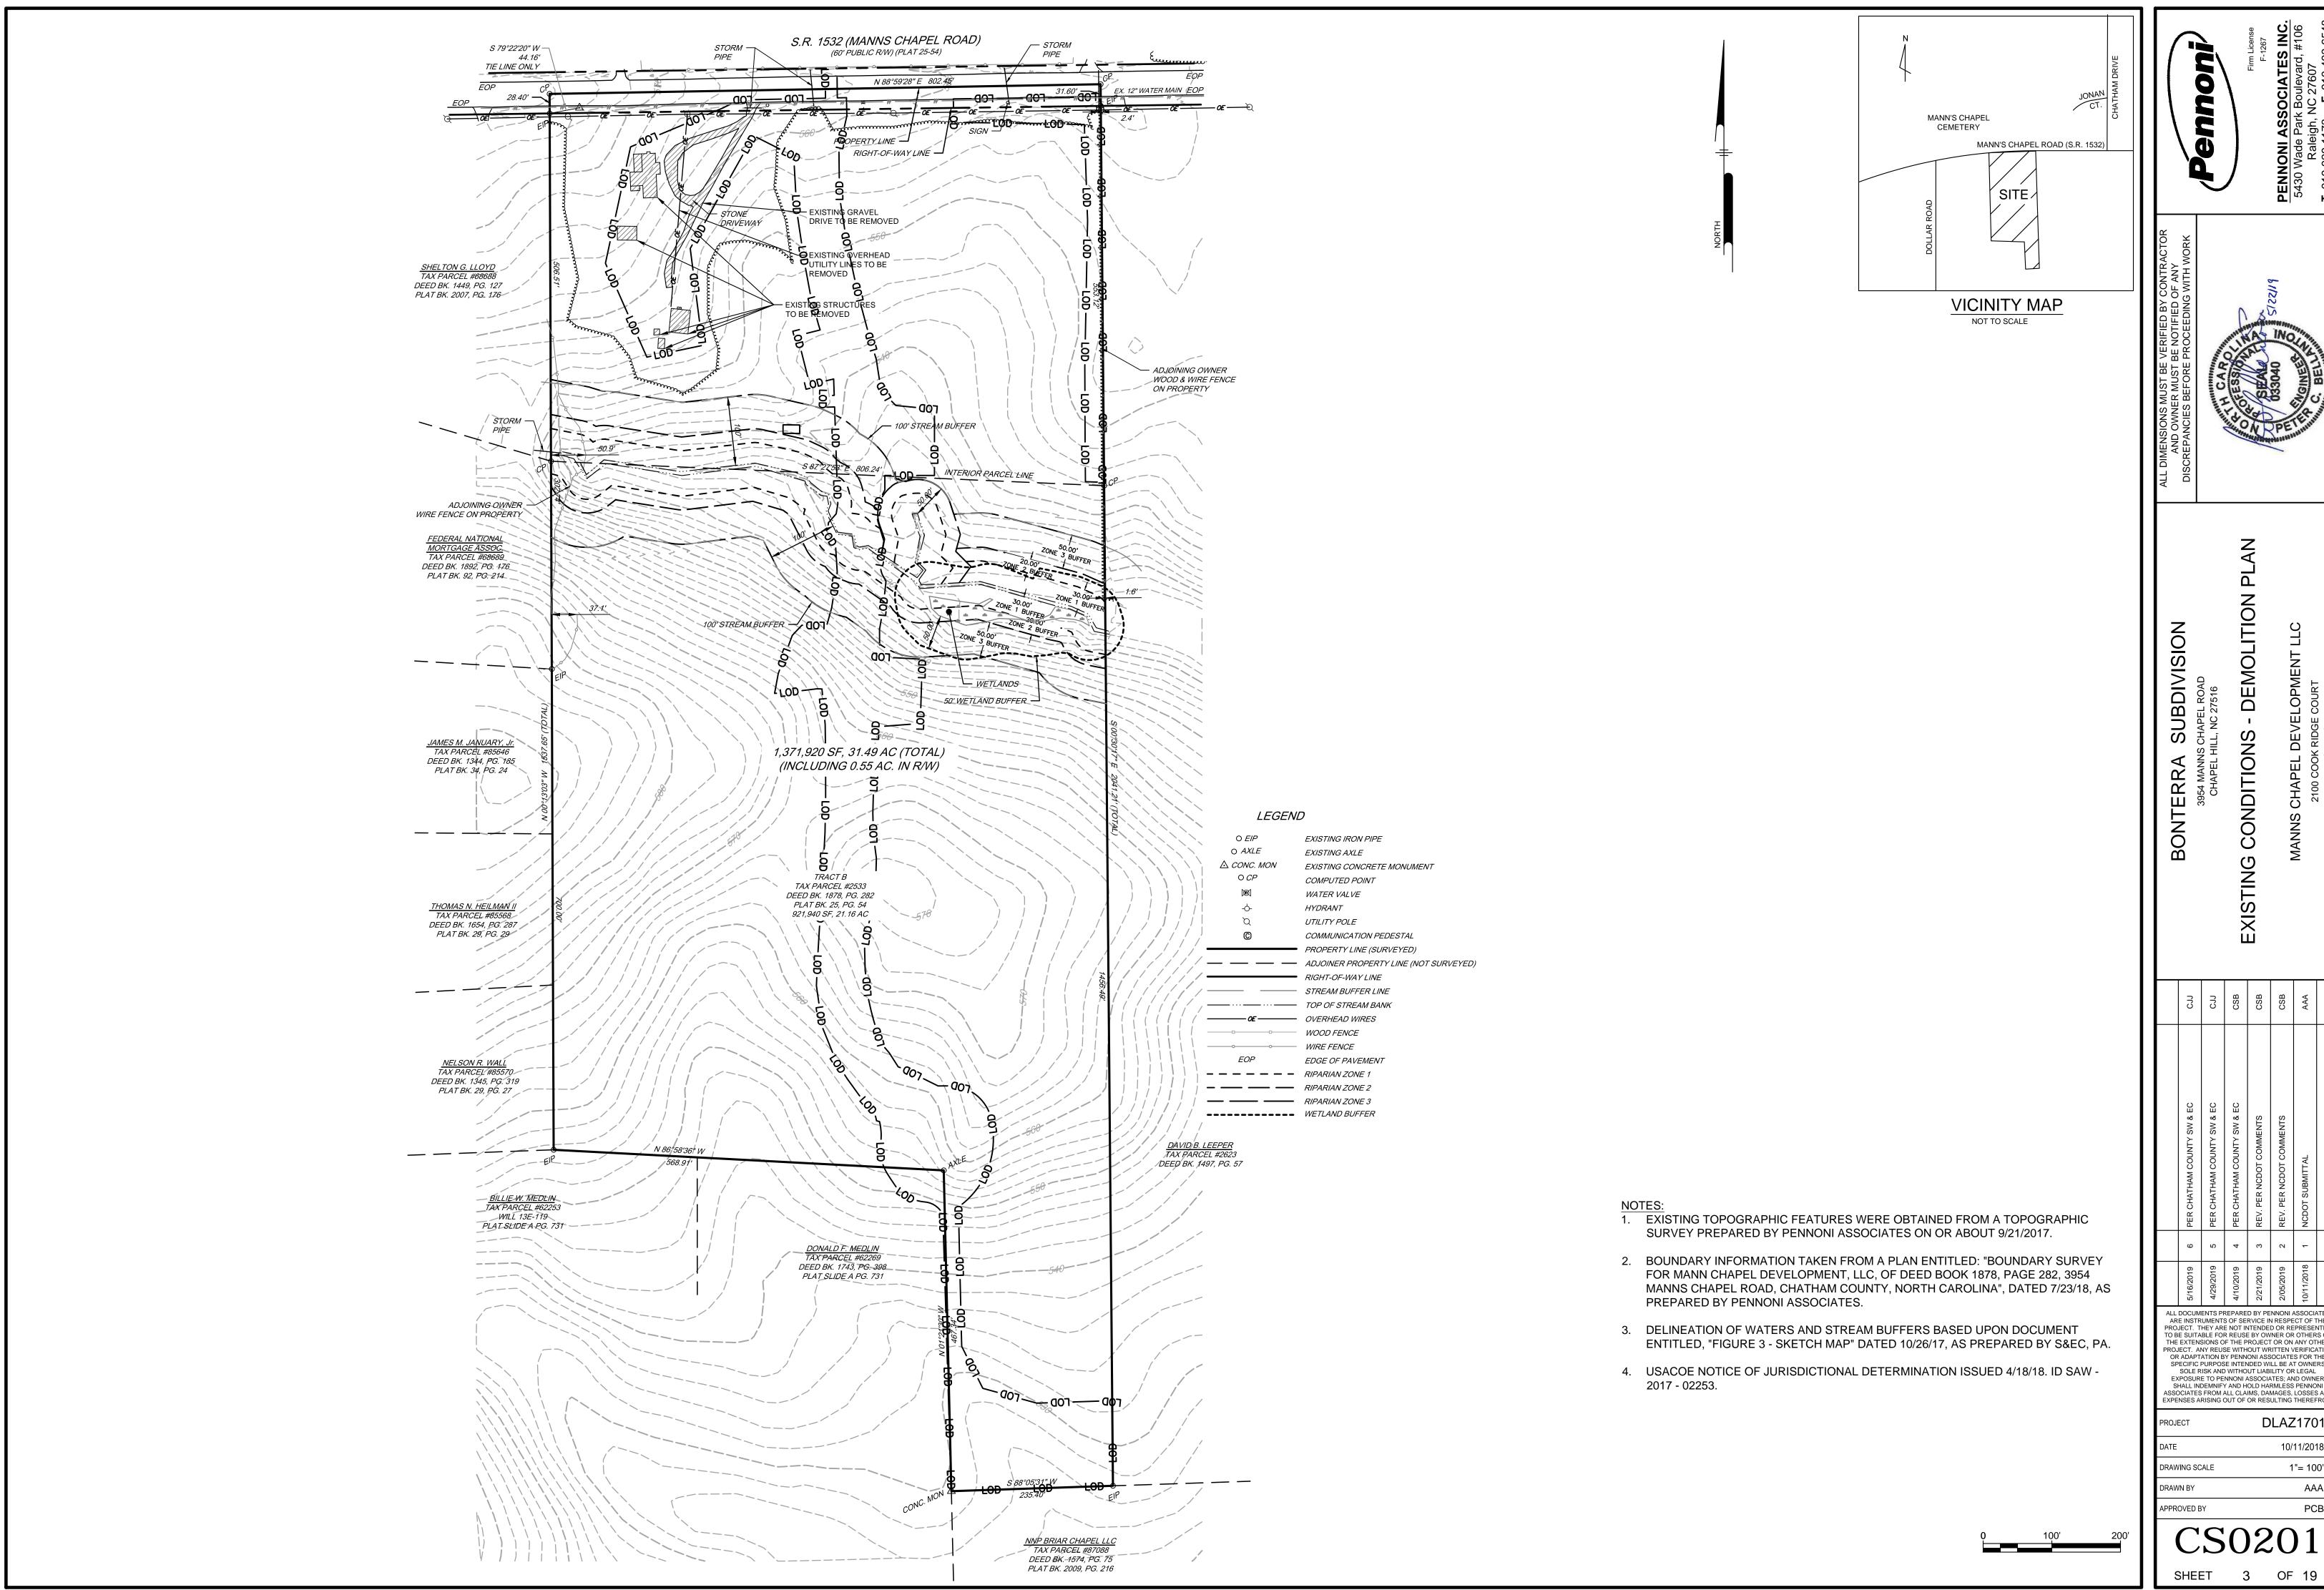


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APPROVED BY	PCB

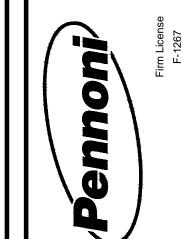

		LOT AREA	TABLE		
LOT#	TOTAL AREA (sf)	AREA (ac)	AREA IN BUFFER	STREAM AREA	USABLE AREA
LOT 1	52,022 SF	1.19	0	0	52,022 SF
LOT 2	50,439 SF	1.15	0	0	50,439 SF
LOT 3	49,909 SF	1.14	0	0	49,909 SF
LOT 4	97,279 SF	2.23	37,613 SF	1,359 SF	58,307 SF
LOT 5	77,300 SF	1.77	36,184 SF	939 SF	40,177 SF
LOT 6	40,172 SF	0.92	0	0	40,165 SF
LOT 7	40,037 SF	0.92	0	0	40,032 SF
LOT 8	41,521 SF	0.95	0	0	41,520 SF
LOT 9	41,473 SF	0.95	0	0	41,473 SF
LOT 10	45,509 SF	1.04	0	0	45,509 SF
LOT 11	48,057 SF	1.10	0	0	48,057 SF
LOT 12	53,156 SF	1.22	0	0	53,156 SF
LOT 13	45,867 SF	1.05	0	0	45,867 SF
LOT 14	43,255 SF	0.99	0	0	43,255 SF
LOT 15	40,167 SF	0.92	0	0	40,167 SF
LOT 16	40,102 SF	0.92	0	0	40,102 SF
LOT 17	40,018 SF	0.92	0	0	40,018 SF
LOT 18	40,054 SF	0.92	0	0	40,054 SF
LOT 19	77,432 SF	1.78	36,546 SF	857 SF	40,029 SF
LOT 20	109,139 SF	2.50	39,869 SF	1,419 SF	67,851 SF
LOT 21	78,530 SF	1.80	3,474 SF	131 SF	74,925 SF
LOT 22	111,377 SF	2.55	7,934 SF	115 SF	103,328 SF

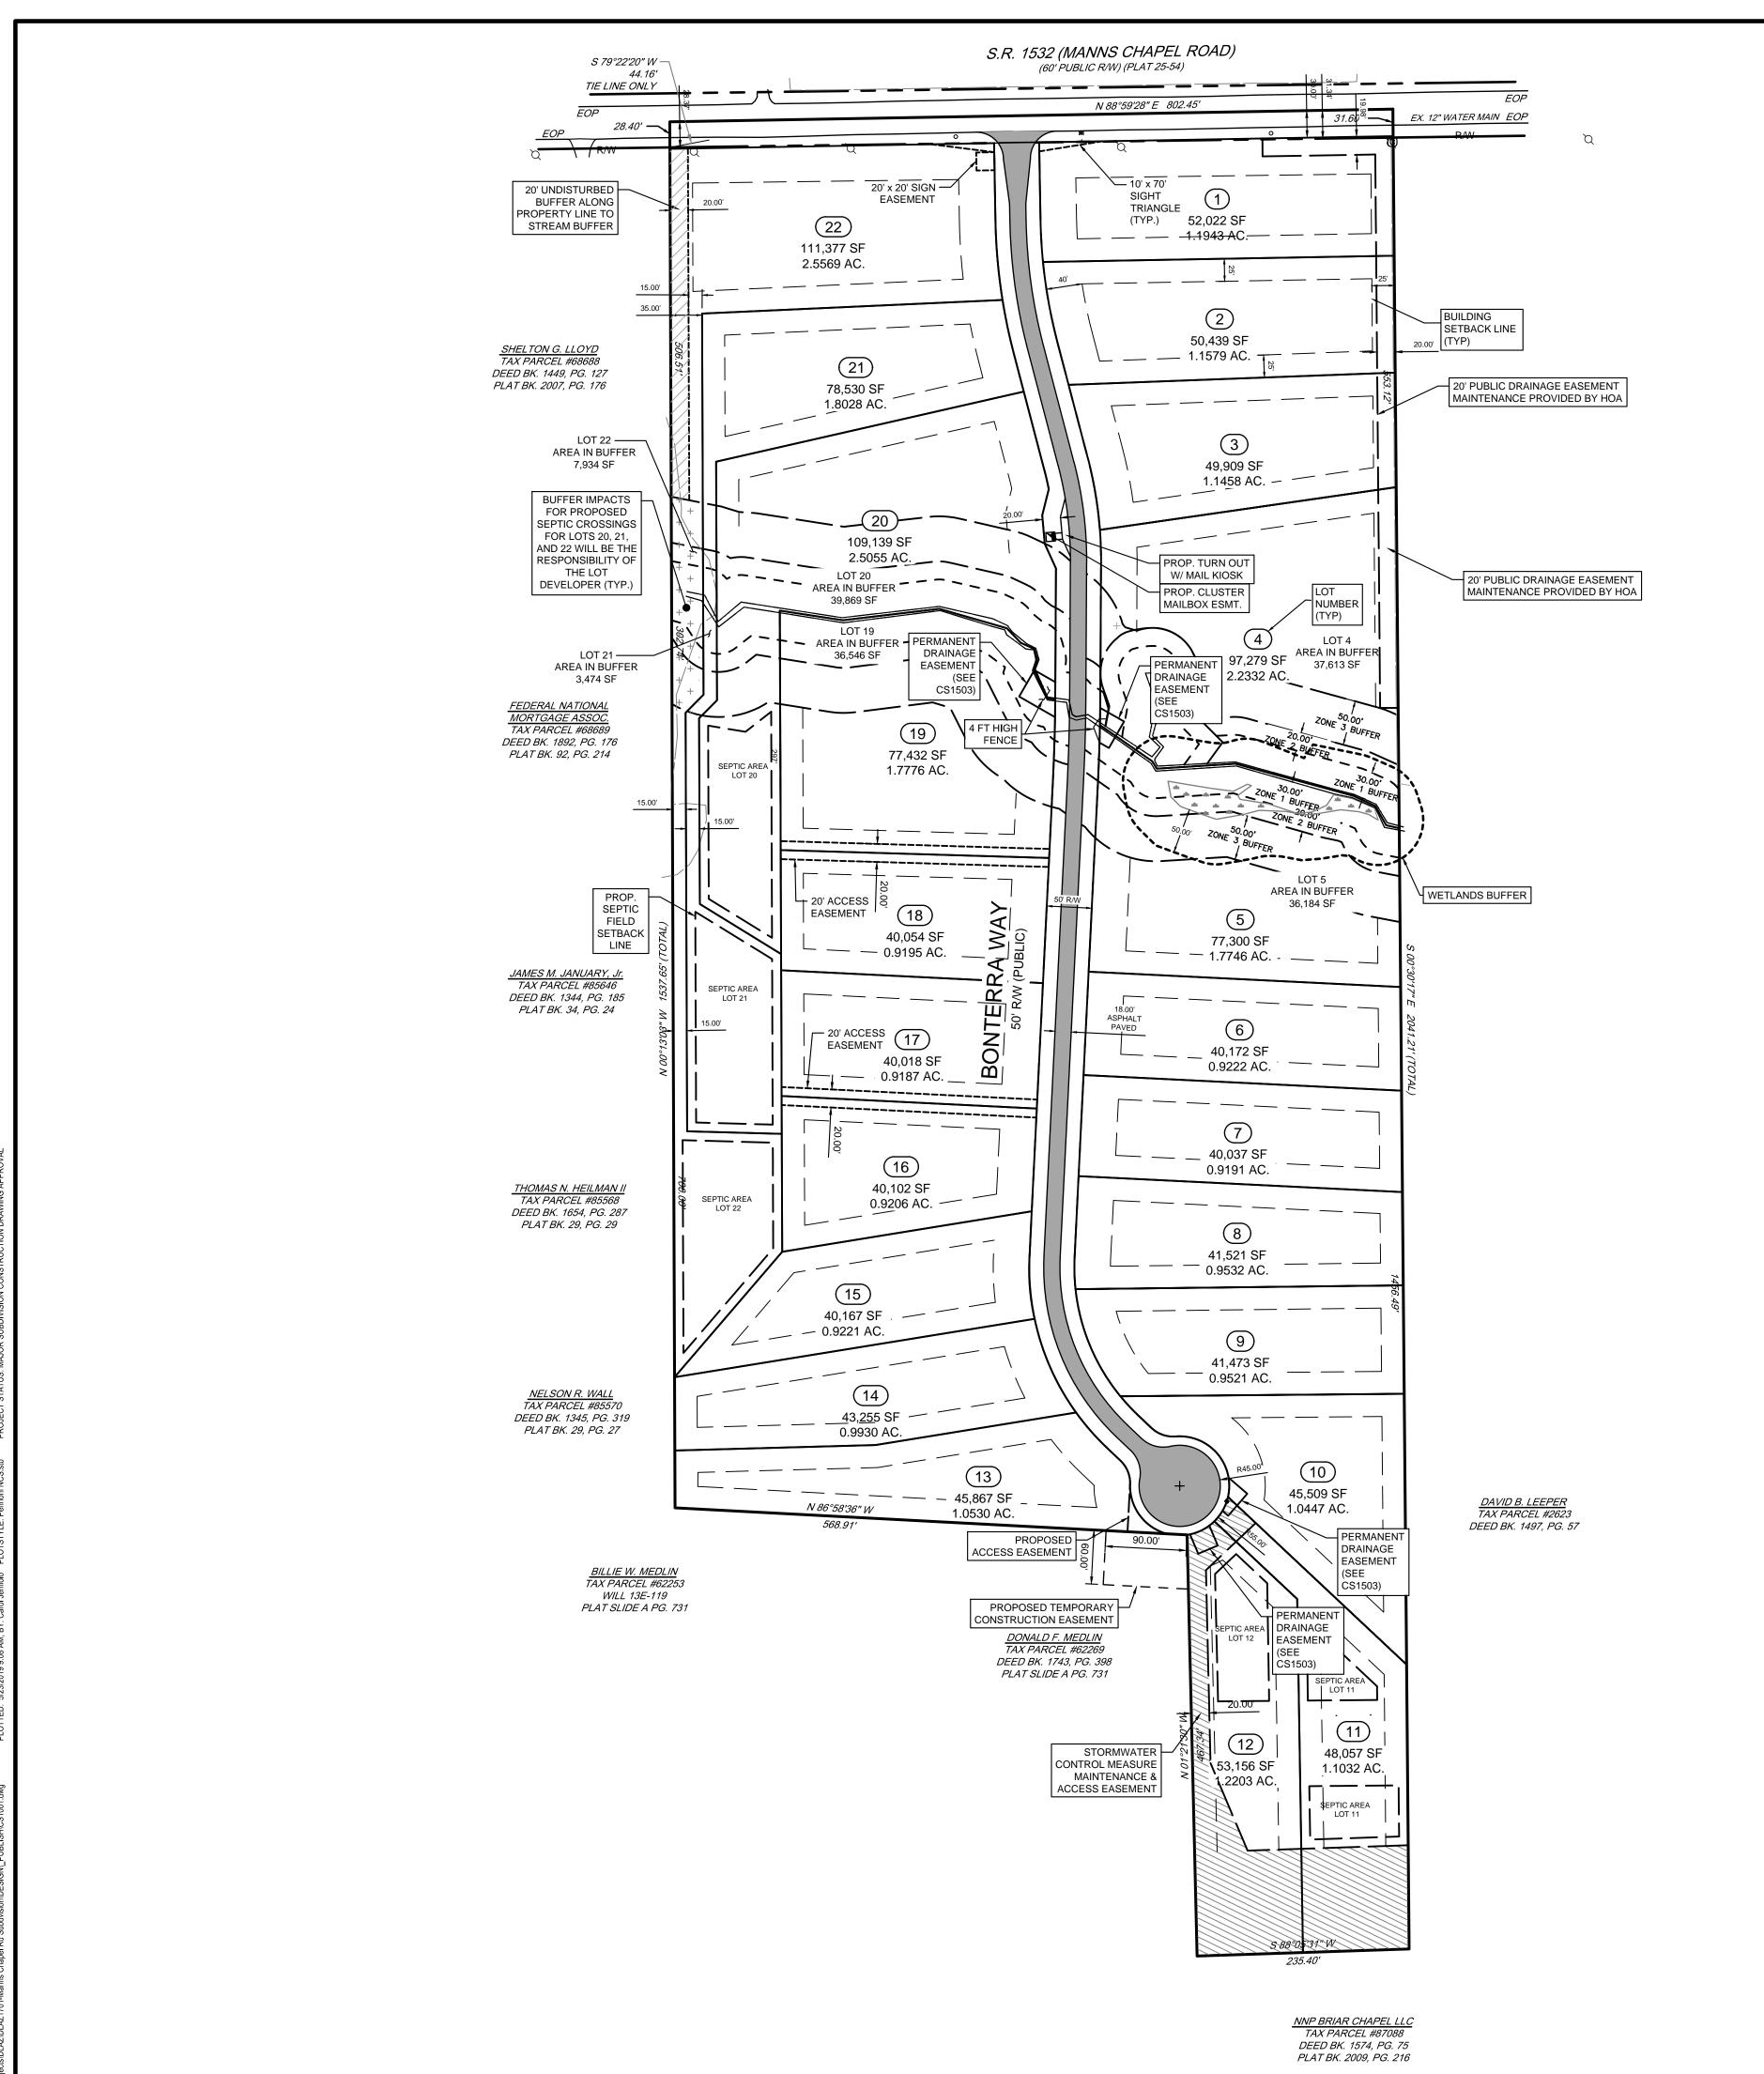BUFFER LEGEND

- - - - - - RIPARIAN ZONE 1 - - RIPARIAN ZONE 2 RIPARIAN ZONE 3 RIPARIAN ZONE 1 HATCH RIPARIAN ZONE 2 HATCH RIPARIAN ZONE 3 HATCH

----- WETLAND BUFFER

UPON ADDITION OF A ROAD TO THE STATE SYSTEM, NCDOT WOULD NOT OWN OR MAINTAIN CLUSTER MAILBOX UNITS (CBU'S) OR OTHER APPURTENANCES ASSOCIATED WITH THESE UNITS SUCH AS CONCRETE PADS. THE CBU'S AND APPURTENANCES SHALL BE CONSIDERED AN ENCROACHMENT AND ADMINISTERED IN ACCORDANCE WITH THE CURRENT EDITION OF THE POLICIES AND PROCEDURES FOR ACCOMMODATING UTILITIES ON HIGHWAY RIGHTS OF WAY. IN ADDITION, NCDOT WOULD NOT BE RESPONSIBLE FOR CLEARING SNOW, ICE, LIMBS, TRASH ACCUMULATION, SPECIALIZED VEGETATION MANAGEMENT, ETC. FROM ASSOCIATED PARKING AREAS (IF APPLICABLE) AND THE IMMEDIATE AREA AROUND THE CBU. THESE MAINTENANCE ACTIVITIES MUST BE PROVIDED BY MAILBOX USERS OF HOMEOWNER'S ASSOCIATION AS A CONDITION OF THE ENCROACHMENT AGREEMENT.

SINGLE FAMILY RESIDENTIAL LOTS:

AT LEAST ONE OF THE FOLLOWING DESIGN STANDARDS SHALL BE UTILIZED IN THE DEVELOPMENT OR REDEVELOPMENT OF AN INDIVIDUAL LOT FOR A SINGLE FAMILY

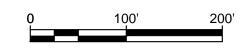
> I. ALL ROOF DOWNSPOUTS SHALL DISCHARGE ONTO THE SURFACE OF THE NATURAL GROUND AT-LEAST 25 FEET FROM THE PROPERTY BOUNDARY AND IN ACCORDANCE WITH ALL APPLICABLE BUILDING CODES;

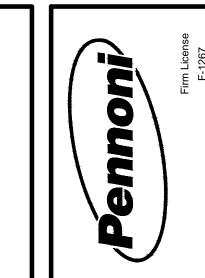
> II. COLLECT THE FIRST $\frac{1}{2}$ " EQUIVALENT RUNOFF VOLUME FROM AT LEAST $\frac{1}{2}$ OF THE TOTAL ROOF AREA BY CONNECTING DOWNSPOUTS TO OPERATING RAIN BARRELS OR CISTERNS;

III. DRIVEWAYS, WALKWAYS AND PATIOS SHALL DRAIN INTO WELL-MAINTAINED LANDSCAPED BEDS USING NATIVE VEGETATION AND AMENDED SOILS.

THESE RESIDENTIAL STORMWATER PRACTICES SHALL BE RECORDED ON THE PLAT FOR THIS DEVELOPMENT.

WITHIN THIS LOW-DENSITY DEVELOPMENT, THERE IS NO IMPERVIOUS COVER RESTRICTION FOR SINGLE-FAMILY LOTS. ALL CHANGES MADE TO PROPERTIES SHOULD NOT SIGNIFICANTLY ALTER THE STORMWATER MANAGEMENT PLAN FOR THE DEVELOPMENT.






CAROLINE SEAL STRAINS


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5/16/2019	6	PER CHATHAM COUNTY SW & EC	CJJ
4/29/2019	5	PER CHATHAM COUNTY SW & EC	CJJ
4/10/2019	4	PER CHATHAM COUNTY SW & EC	CSB
2/21/2019	3	REV. PER NCDOT COMMENTS	CSB
2/05/2019	2	REV. PER NCDOT COMMENTS	CSB
10/11/2018	1	NCDOT SUBMITTAL	AAA
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PENNONI ASSOCIA 5430 Wade Park Boule Raleigh, NC 27

DISCREPANCIES BEFORE PROCEEDING WITH W

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ITY PLAN (NORTH)

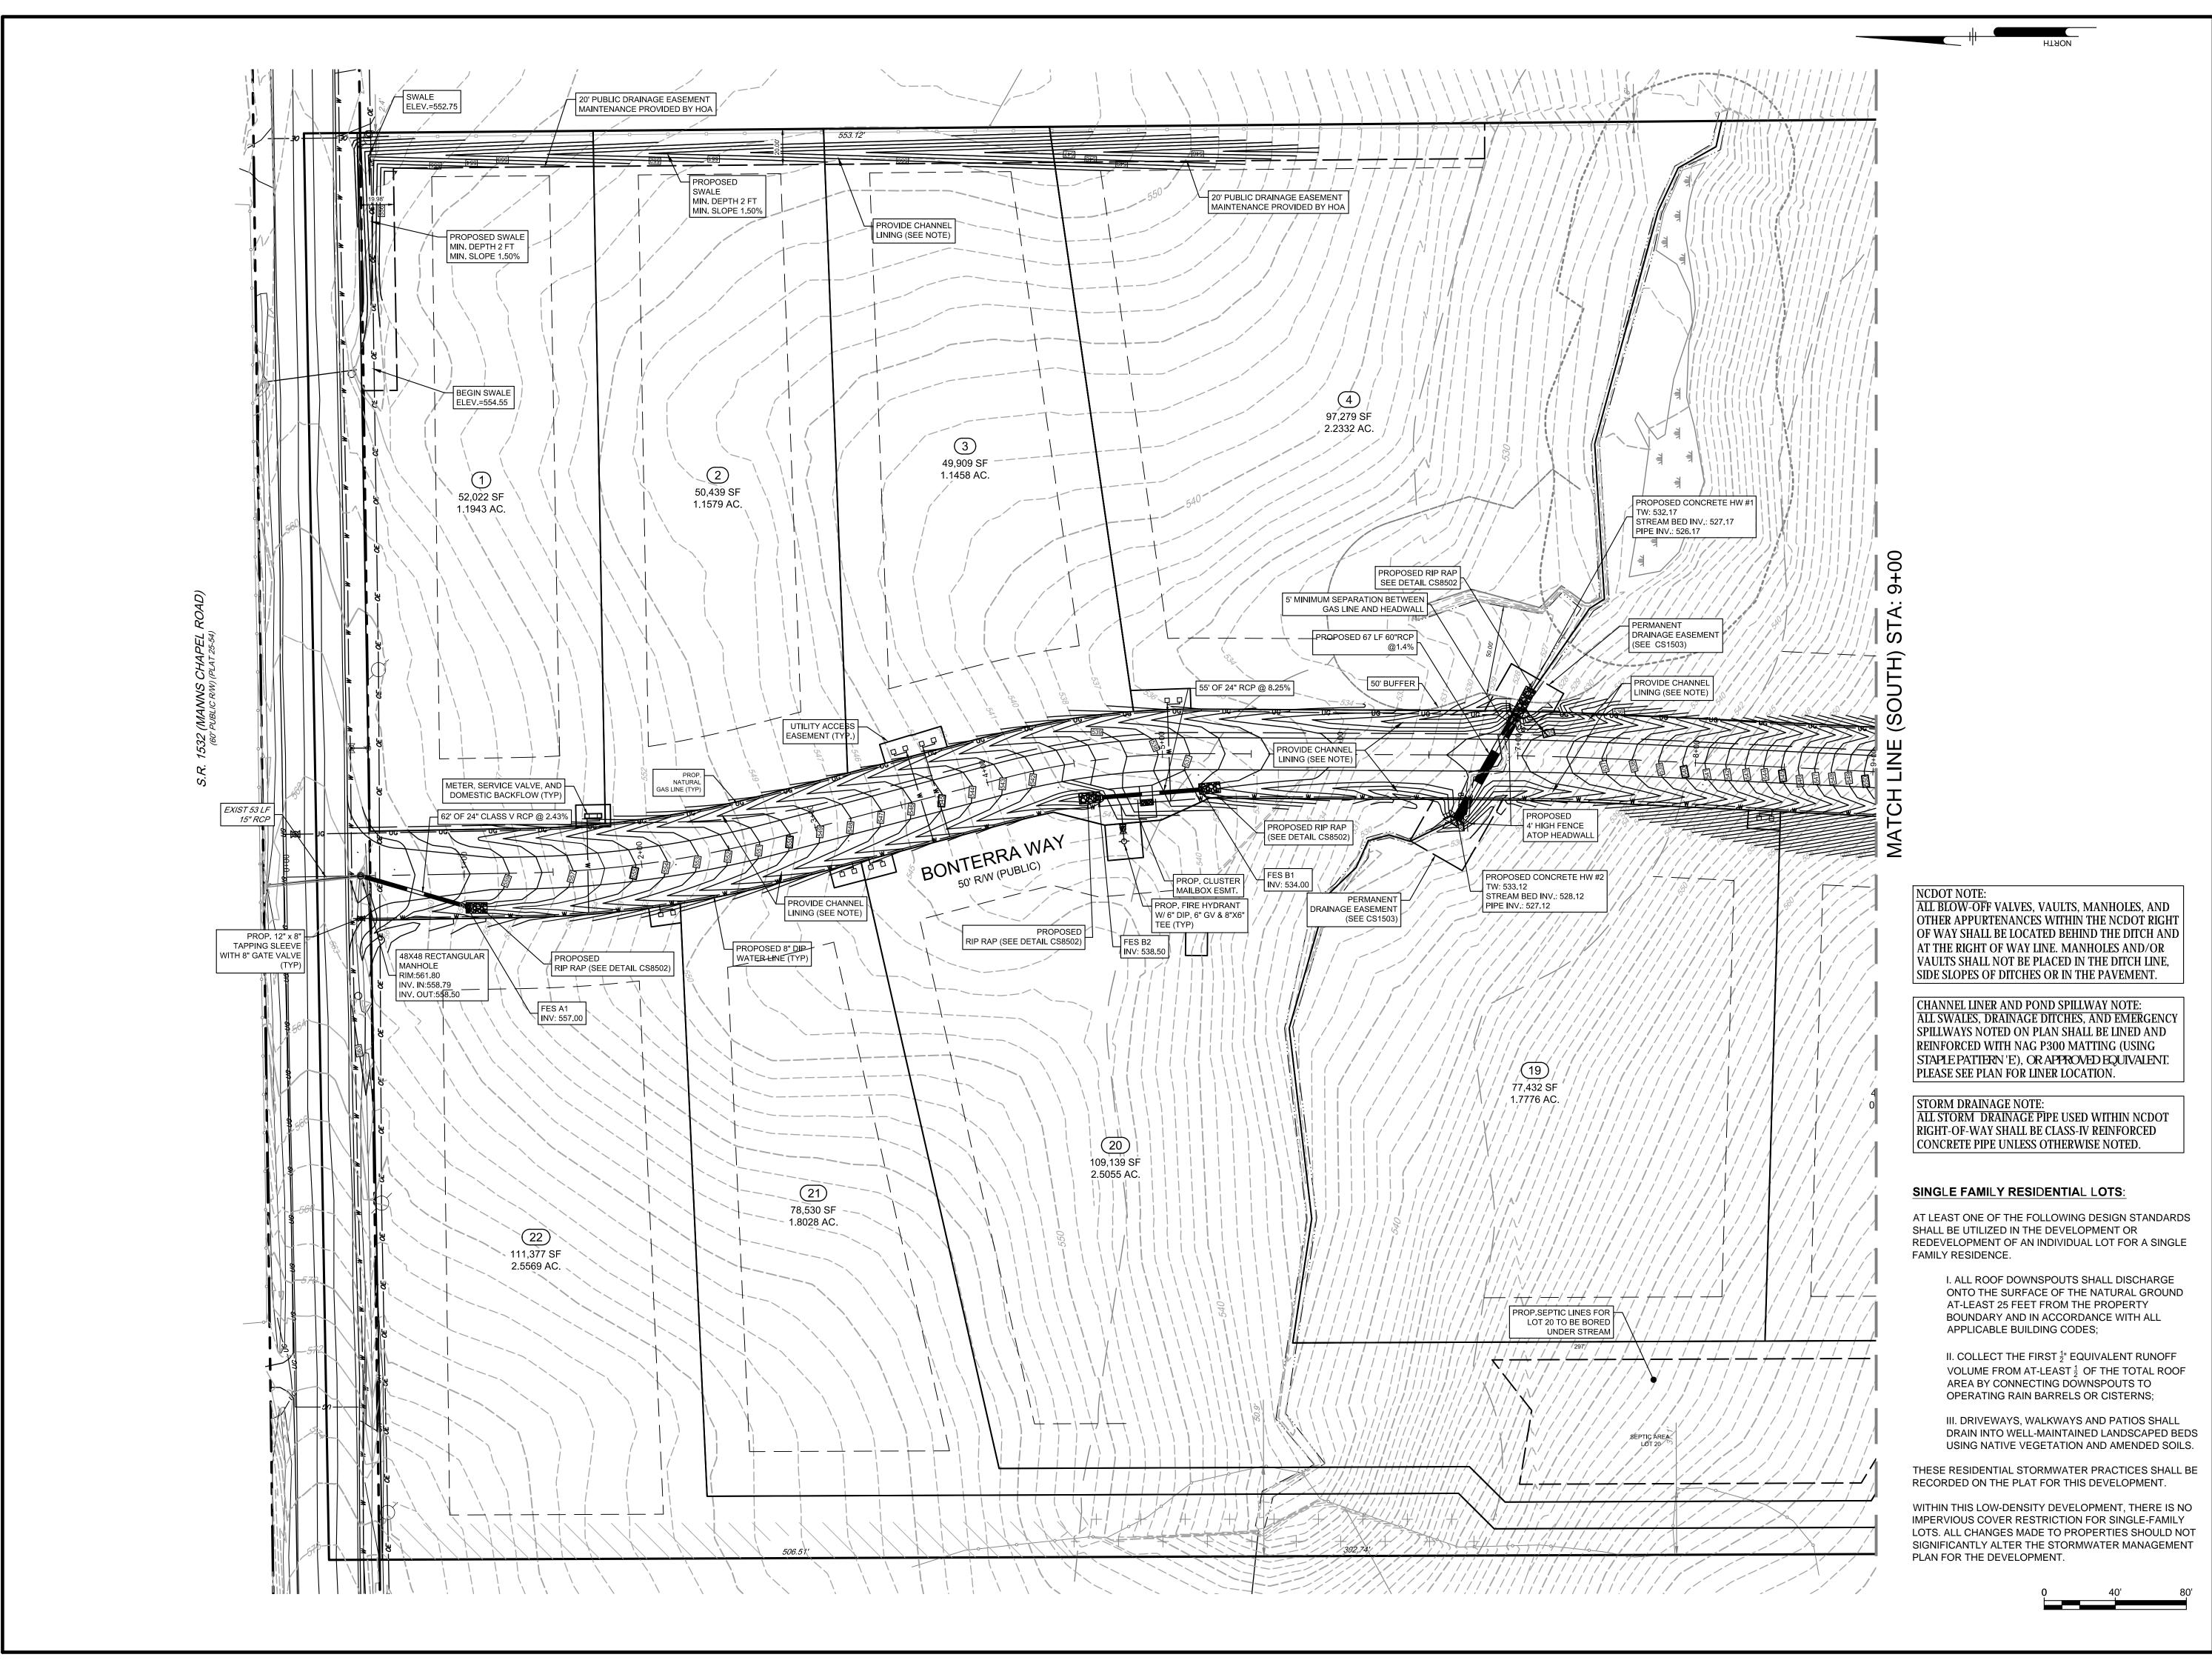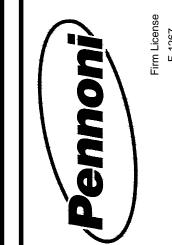CHAPEL HILL, NC 27516
RALL GRADING & UTILITY PLAN

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 PER CHATHAM COUNTY SW & EC
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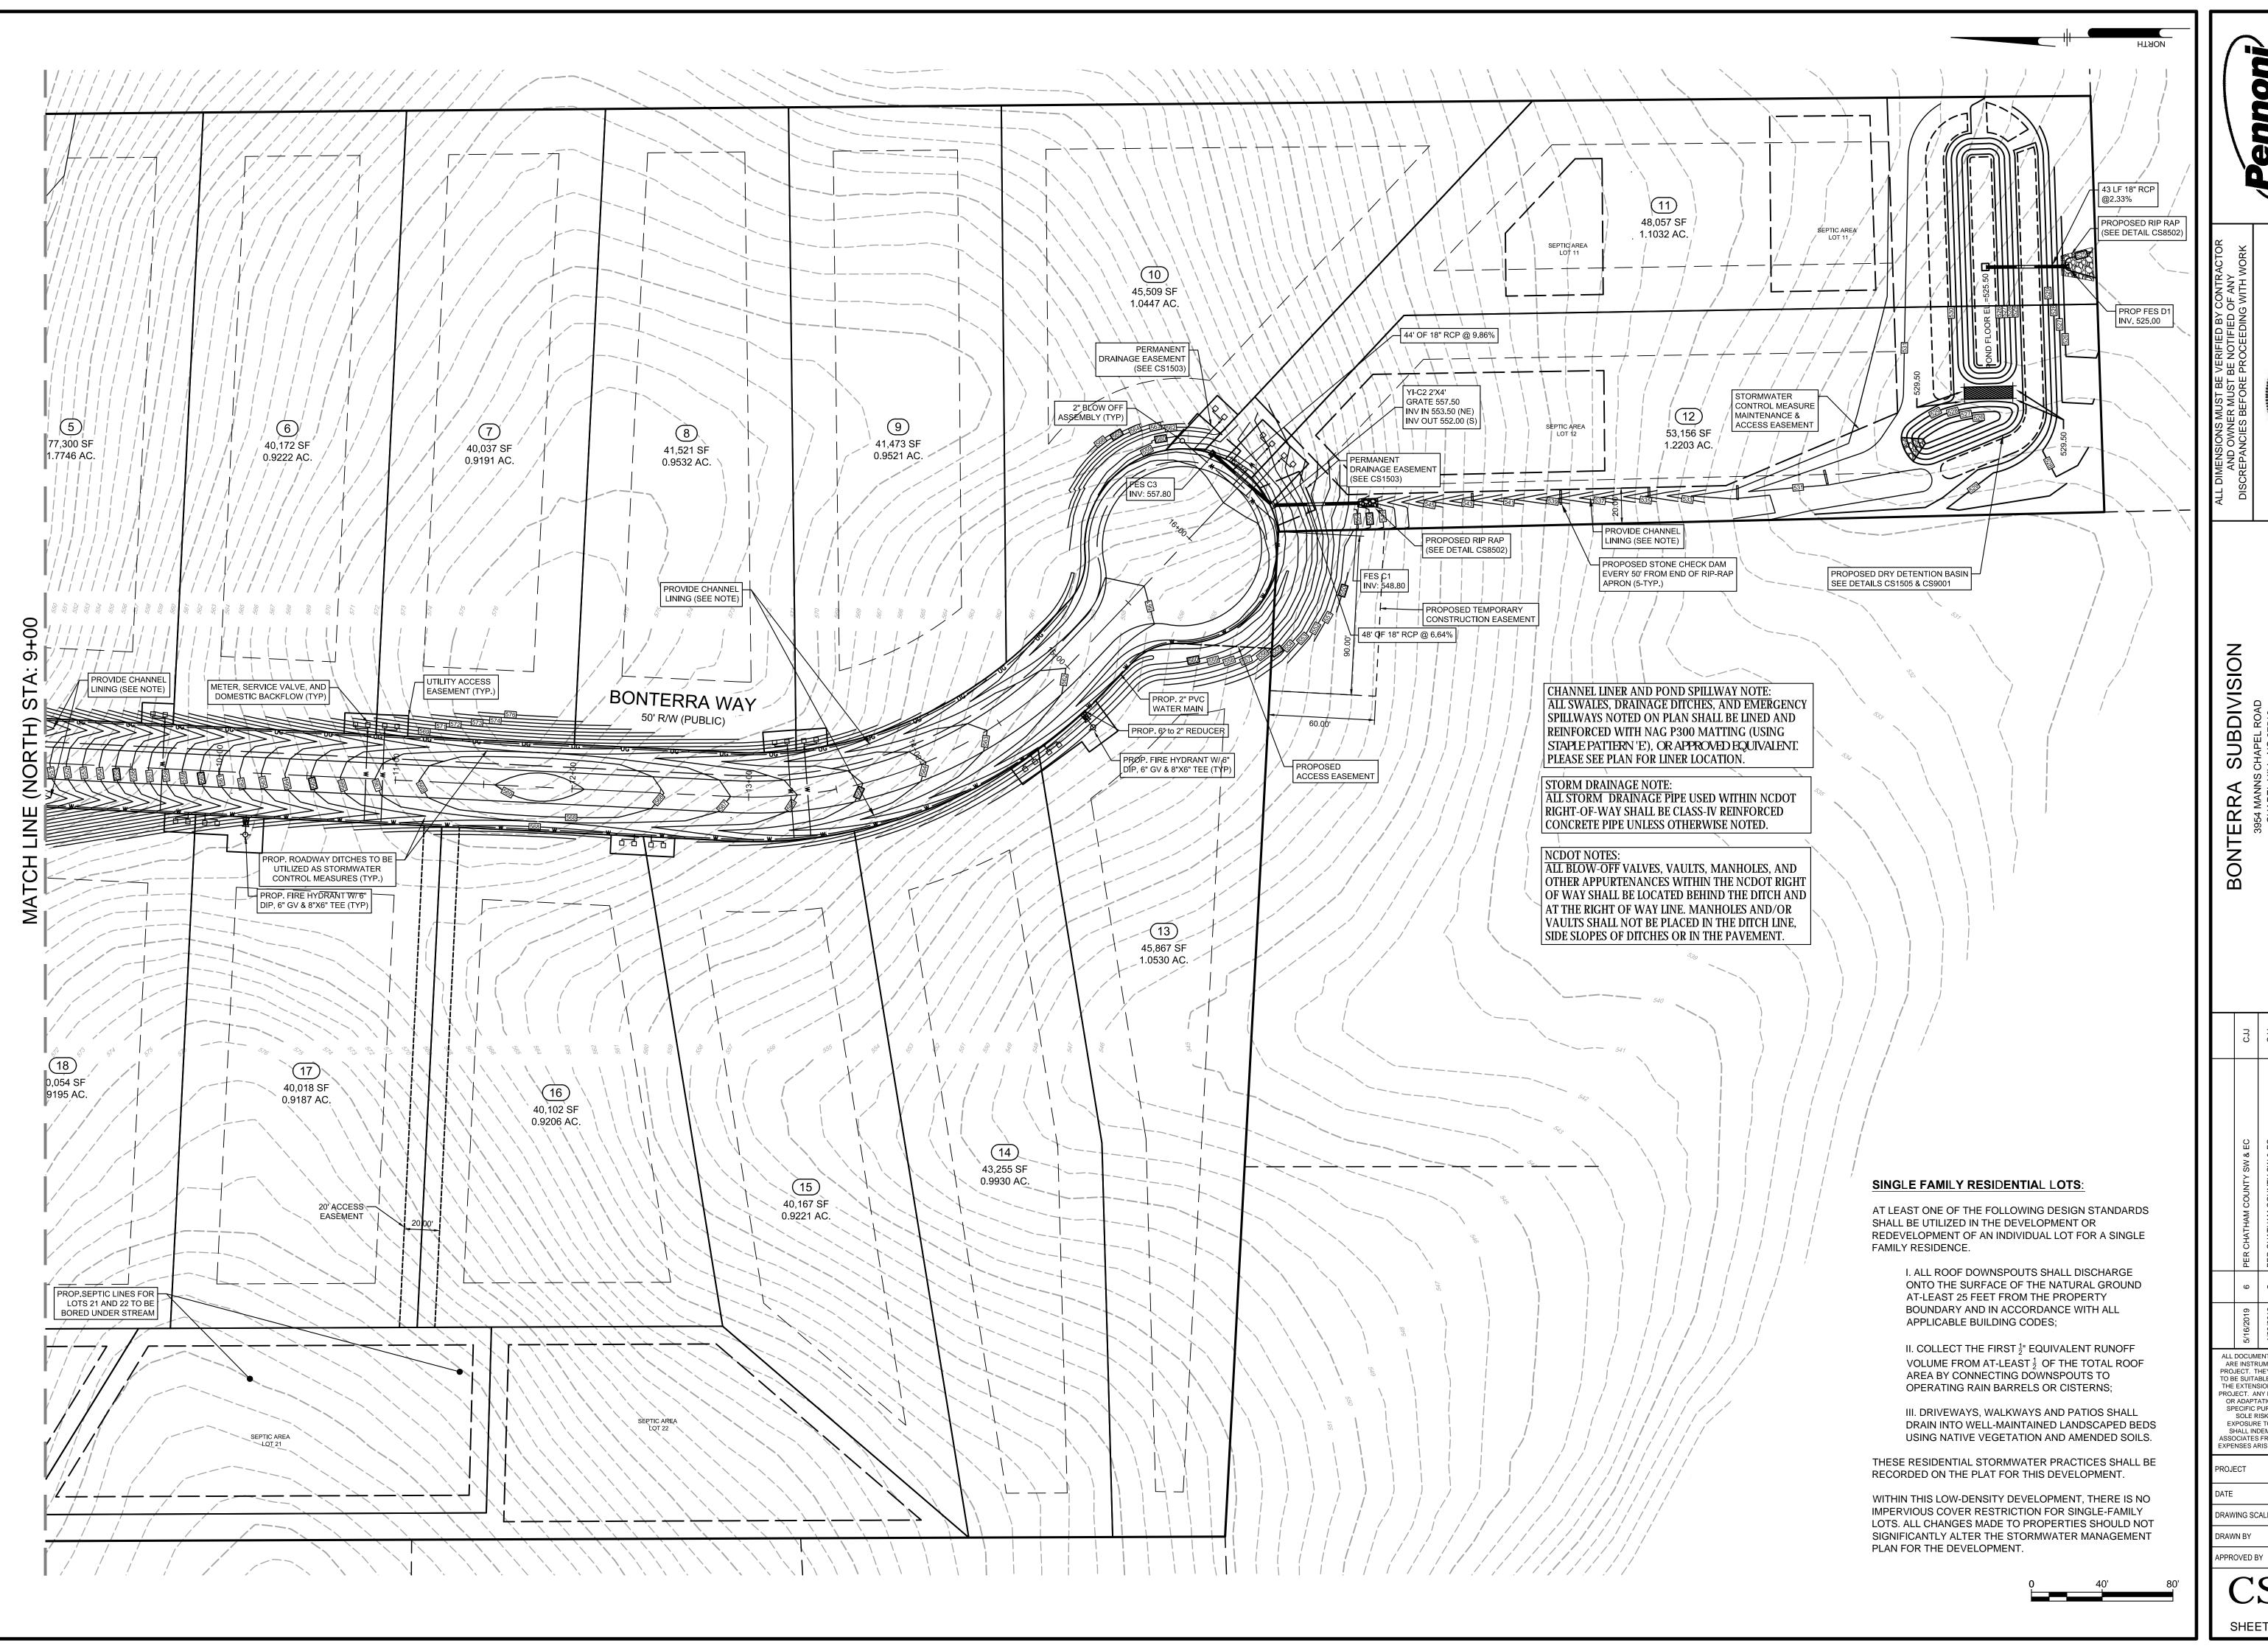
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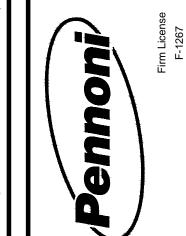
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